32-34 Georges Bay Esplanade St Helens Tasmania 7216 T: 03 6376 7900 ABN 96 017 131 248



Development Applications

Notice is hereby given under Section 57(3) of the Land Use Planning & Approvals Act 1993 that an application has been made to the Break O' Day Council for a permit for the use or development of land as follows:

DA Number DA 2025 / 00140 **Applicant** Prime Design

Proposal Residential - Construction of a Dwelling and Frontage Fences Location 7-11 Freshwater Street, Beaumaris (CT184539/1 & CT184539/2)

Plans and documents can be inspected at the Council Office by appointment, 32 - 34 Georges Bay Esplanade, St Helens during normal office hours or online at www.bodc.tas.gov.au.

Representations must be submitted in writing to the General Manager, Break O'Day Council, 32 -34 Georges Bay Esplanade, St Helens 7216 or emailed to admin@bodc.tas.gov.au, and referenced with the Application Number in accordance with section 57(5) of the abovementioned Act during the fourteen (14) day advertised period commencing on Saturday 1st November, 2025 until 5pm Monday 17th November, 2025.

John Brown **GENERAL MANAGER**


PROPOSED NEW RESIDENCE 7-11 FRESHWATER STREET, **BEAUMARIS**

R. & E. MURPHY

PD25023

BUILDING DRAWINGS

<u>No</u>	<u>DRAWING</u>
01	SITE PLAN
02	SITE DRAINAGE PLAN
03	LOCALITY PLAN
04	GROUND FLOOR PLAN
05	FIRST FLOOR PLAN
06	DOOR AND WINDOW SCHEDULES
07	ELEVATIONS
80	ELEVATIONS
09	ROOF PLAN
10	PERSPECTIVES

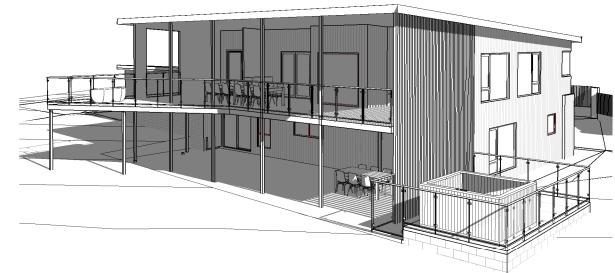



10 Goodman Court, Invermay Launceston 7248 **p(l)** +03 6332 3790


Shop 9, 105-111 Main Road, Moonah Hobart 7009 p(h)+03 6228 4575

info@ primedesigntas.com.au primedesigntas.com.au Accredited Building Practitioner: Frank Geskus -No CC246A

NOVEMBER 2025

TOTAL AREA	436.03	1112	46 94	- SQUARLS
FIRST FLOOR DECK AREA	81 8 9	m2	გ გ1	SQUARES
FIRST FLOOR AREA	143.81	m2	15.48	SQUARES
GROUND FLOOR DECK AREA	72.25	m2	7.78	SQUARES
GROUND FLOOR AREA	138.08	m2	14.86	SQUARES



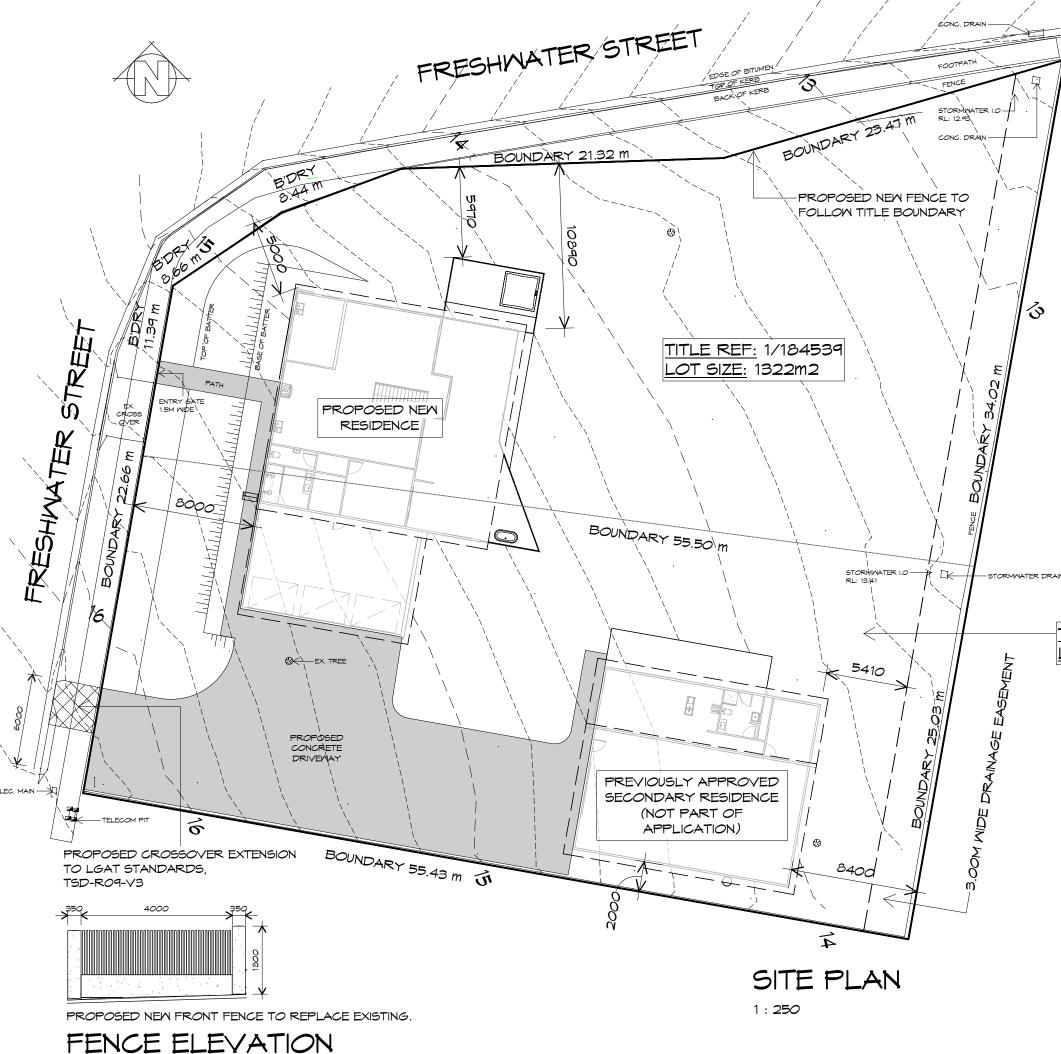

SURVEYOR: LJLDATE: 24/03/25

- 1. THIS PLAN HAS BEEN PREPARED BY WOOLCOTT LAND SERVICES FROM A COMBINATION OF EXISTING RECORDS AND FIELD SURVEY FOR THE PURPOSES OF SHOWING THE PHYSICAL FEATURES OF THE LAND AND SHOULD NOT USED FOR ANY OTHER PURPOSE.
- 2. TITLE BOUNDARIES SHOWN WERE NOT MARKED AT THE TIME OF THIS SURVEY.
- 3. SERVICES SHOWN ON THIS PLAN MERE LOCATED MHERE POSSIBLE BY FIELD SURVEY. THEY ARE NOT A COMPLETE PICTURE OF SERVICES ON SITE. ALL SERVICE LOCATIONS ARE TO BE VERIFIED BEFORE COMMENCMENT OF ANY MORK ON SITE, IN PARTICULAR THOSE SERVICES NOT PREVIOUSLY LOCATED THROUGH FIELD SURVEY.
- 4. MOOLCOTT LAND SERVICES CAN NOT ACCEPT LIABILITY WHATSOEVER FOR LOSS OR DAMAGE CAUSED TO ANY UNDERGROUND SERVICE WHETHER SHOWN BY OUR SURVEY OR NOT.
- 5. THIS NOTE IS AN INTEGRAL PART OF THIS PLAN/DATA. REPRODUCTION OF THIS PLAN OR ANY PART OF IT WITHOUT THIS NOTE BEING INCLUDED IN FULL WILL RENDER THE INFORMATION SHOWN ON SUCH A REPRODUCTION INVALID AND NOT SUITABLE FOR USE WITHOUT PRIOR AUTHORITY OF WOOLCOTT LAND SERVICES.
- 6. HORIZONTAL BEARING DATUM IS MGA BASED ON RTK GPS.
- 7. VERTICAL DATUM IS ADH'83 BASED PER TASPOS.
- 8. CONTOUR INTERVAL IS 0.20m INDEX IS 1.00m.
- 9. BOUNDARIES AND EASEMENTS ARE COMPILED FROM SIO183865 AND ARE APPROXIMATE AND SUBJECT TO SURVEY.
- 10. CO-ORDINATES ARE PLANE AND BASED ON MGA2020 PER TASPOS

SITE COVERAGE

BUILDING FOOTPRINT (RESIDENCE & SECONDARY DWELLING) 641.5 /SITE AREA 2644 = 0.24

TOTAL SITE COVERAGE 24%

COMPLIES WITH 10.4.4 SITE COVERAGE NOT MORE THAN 30%

TITLE REF: 2/184539 LOT SIZE: 1322m2



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Project:

PROPOSED NEW RESIDENCE 7-11 FRESHWATER STREET, BEAUMARIS

Client name:

R. & E. MURPHY

Drawing:

SITE PLAN


Drafted by:
J.M Approved by:
Approver

Date: Scale:
20.10.2025 As indicated

Project/Drawing no: Revision:

PD25023 -01 06

Accredited building practitioner: Frank Geskus -No CC246A

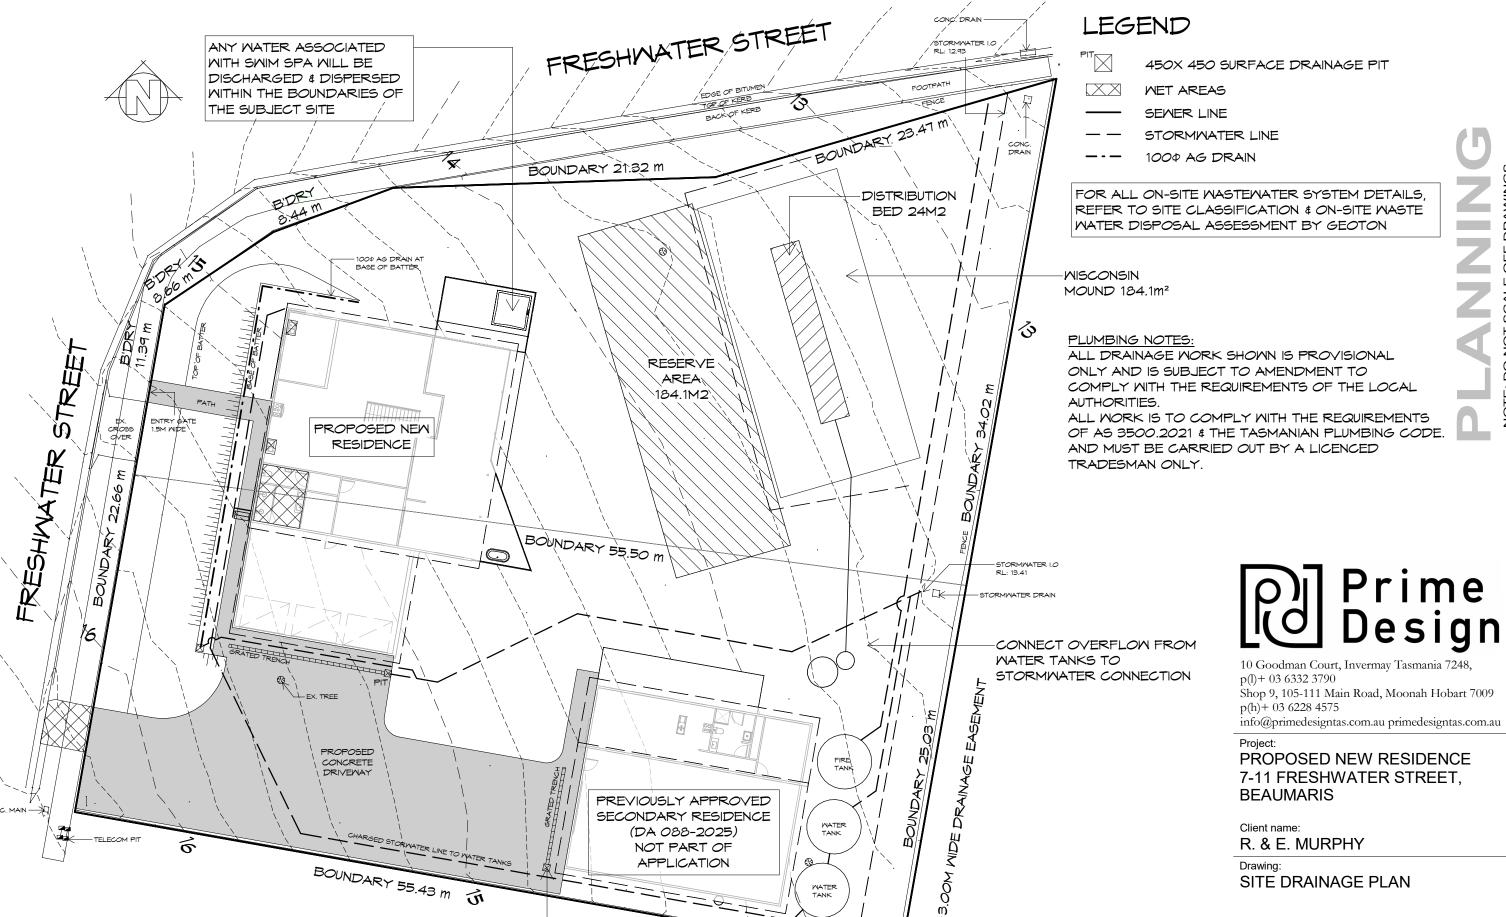

PREVIOUSLY APPROVED DRIVEWAY DRAINAGE

SITE DRAINAGE PLAN

1:250

10 Goodman Court, Invermay Tasmania 7248,

Shop 9, 105-111 Main Road, Moonah Hobart 7009

info@primedesigntas.com.au primedesigntas.com.au

7-11 FRESHWATER STREET,

Drafted by: Author	Approved by: Approver
Date:	Scale:
20.10.2025	As indicated

Project/Drawing no: Revision: PD25023 -02 06

PROPOSED NEW RESIDENCE 7-11 FRESHWATER STREET, BEAUMARIS



LOCALITY PLAN

1:2000

THIS SITE IS ZONED LOW DENSITY RESIDENTIAL IN A BUSHFIRE PRONE AREA AND **REQUIRES** A BUSHFIRE ASSESSMENT.

THIS PROPOSED RESIDENCE HAS BEEN DETERMINED TO HAVE A BUSHFIRE ATTACK LEVEL (BAL) OF BAL-19 REFER TO ASSESSMENT FOR FURTHER DETAILS. ALL CONSTRUCTION MUST COMPLY WITH AS3959.



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Project:

PROPOSED NEW RESIDENCE 7-11 FRESHWATER STREET, BEAUMARIS

Client name:

R. & E. MURPHY


Drafted by: Author

Approved by: Approver BUILDING DESIGNERS

Drawing: **LOCALITY PLAN**

Date: Scale: 20.10.2025 1:2000

Project/Drawing no: Revision: PD25023 -03

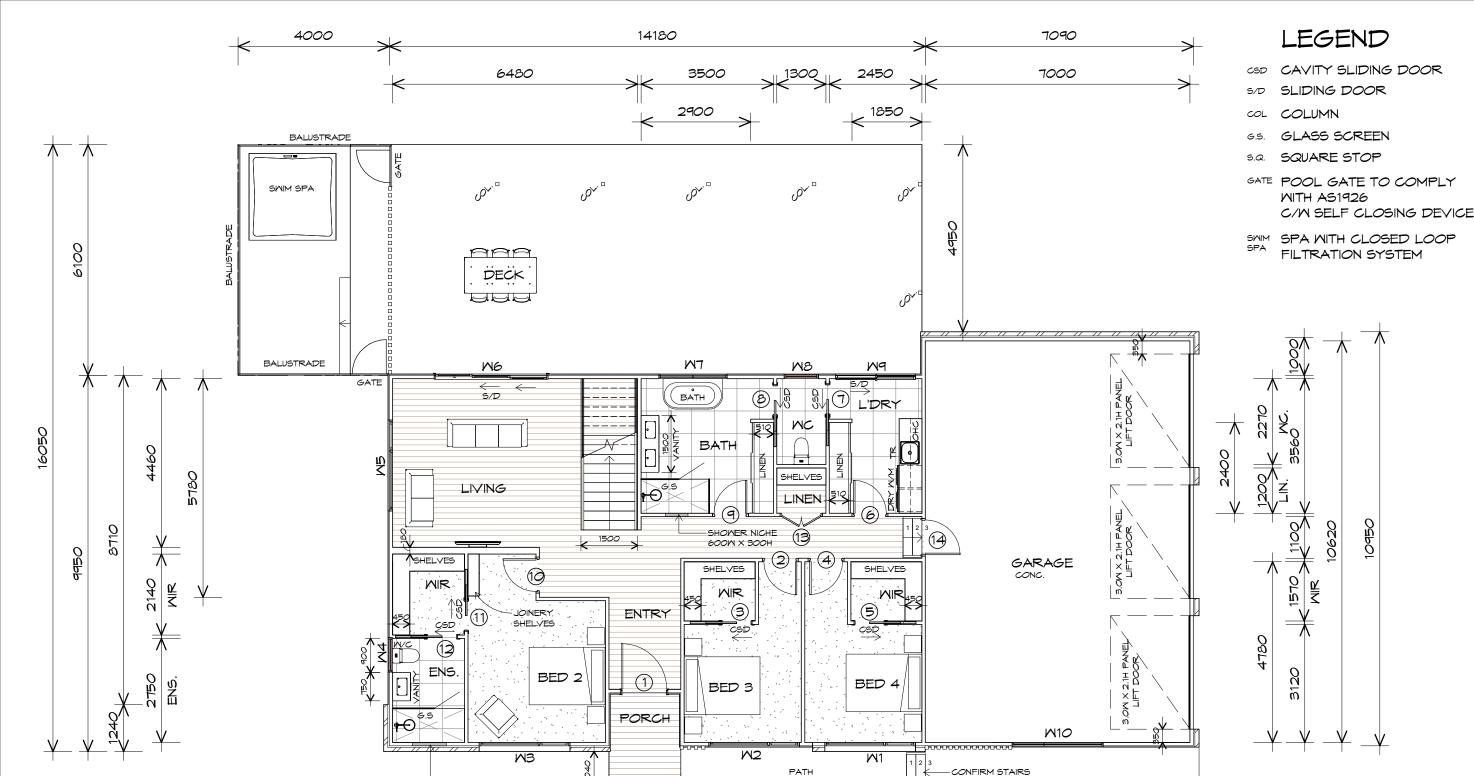

GROUND FLOOR PLAN

1:100

GROUND FLOOR AREA SQUARES 138.08 14.86 GROUND FLOOR DECK AREA SQUARES 72.25 m2 7.78 FIRST FLOOR AREA 143.81 15.48 SQUARES m2 FIRST FLOOR DECK AREA 81.89 8.81 SQUARES m2 TOTAL AREA 436.03 46.94

-SHOWER NICHE

3740

NOTE:

FLOOR AREAS INCLUDE TO EXTERNAL FACE OF BUILDING AND GARAGE, UNLESS OTHERWISE STATED. DECKS AND OUTDOOR AREAS ARE CALCULATED SEPARATELY.



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PROPOSED NEW RESIDENCE 7-11 FRESHWATER STREET, BEAUMARIS

Client name: R. & E. MURPHY

Drafted by: Approved by: J.M **Approver** Drawing:

GROUND FLOOR PLAN

Date: 20.10.2025


Scale: 1:100

Project/Drawing no:

PD25023 -04 Accredited building practitioner: Frank Geskus -No CC246A

Revision:

06

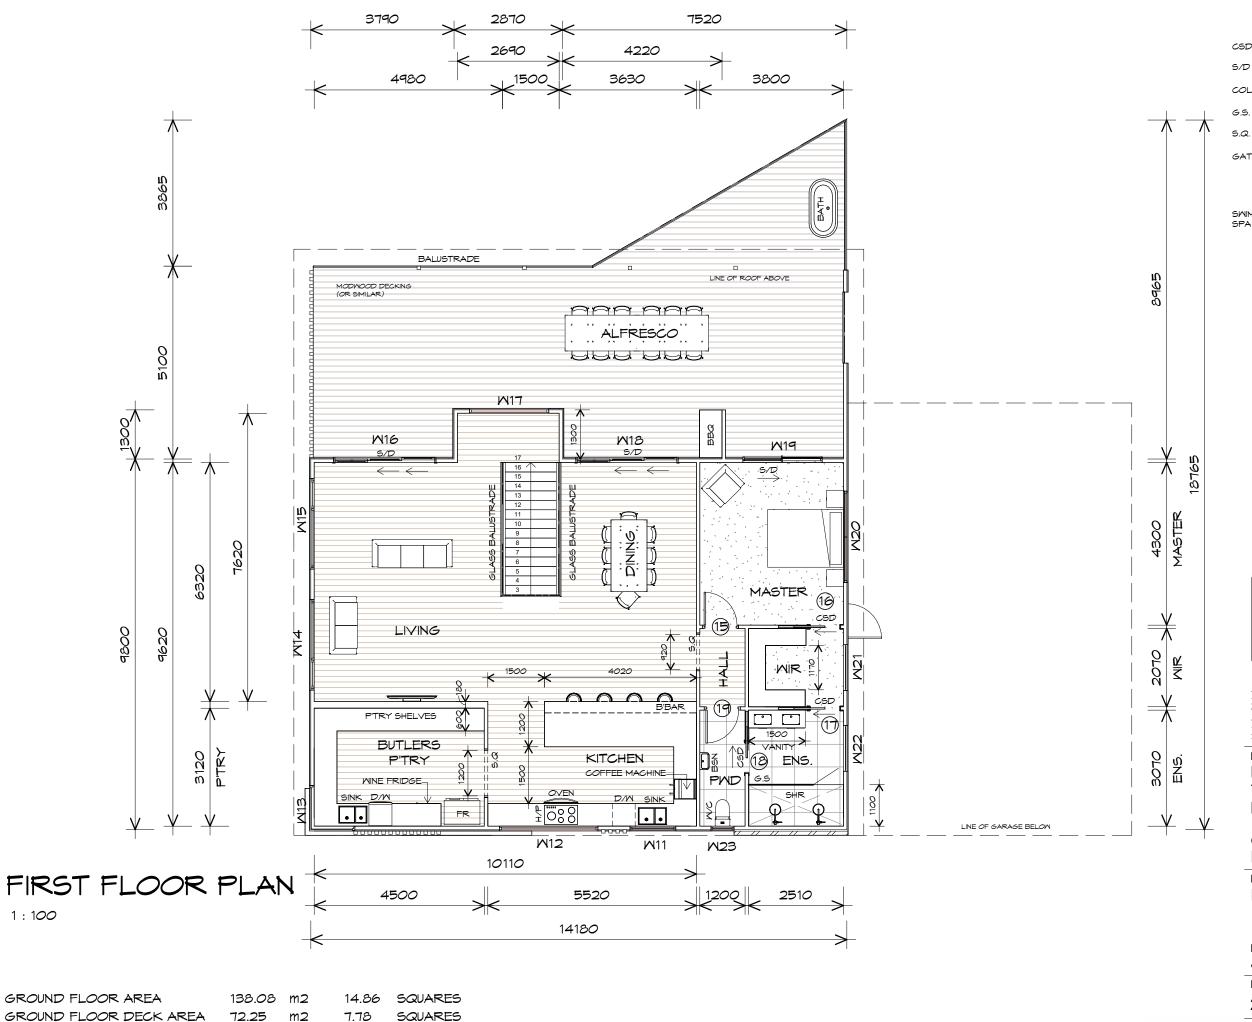

FLOOR AREAS INCLUDE TO EXTERNAL FACE OF BUILDING AND

GARAGE, UNLESS OTHERWISE STATED. DECKS AND OUTDOOR

AREAS ARE CALCULATED SEPARATELY.

SQUARES

SQUARES

143.81

81.89

436.03

m2

m2

15.48

46.94

8.81

FIRST FLOOR AREA

TOTAL AREA

FIRST FLOOR DECK AREA

LEGEND

- CSD CAVITY SLIDING DOOR
- S/D SLIDING DOOR
- COL COLUMN
- G.S. GLASS SCREEN
- s.a. SQUARE STOP
- GATE POOL GATE TO COMPLY WITH AS1926
 - C/W SELF CLOSING DEVICE
- SMIM SPA WITH CLOSED LOOP FILTRATION SYSTEM





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Projec

PROPOSED NEW RESIDENCE 7-11 FRESHWATER STREET, BEAUMARIS

Client name:

R. & E. MURPHY

Drawing:

FIRST FLOOR PLAN

Drafted by: J.M	Approved by: Approver
Date:	Scale:
20.10.2025	1:100

20.10.2025 1 : 100

Project/Drawing no: Revision: PD25023 -05 06

GROUND FLOOR DOOR SCHEDULE					
MARK	MIDTH	TYPE	REMARKS		
1	1200	EXTERNAL ENTRY DOOR			
2	870	INTERNAL TIMBER DOOR			
3	820	CAVITY SLIDING DOOR			
4	870	INTERNAL TIMBER DOOR			
5	820	CAVITY SLIDING DOOR			
6	870	INTERNAL TIMBER DOOR			
7	820	CAVITY SLIDING DOOR			
ප	820	CAVITY SLIDING DOOR			
9	870	INTERNAL TIMBER DOOR			
10	870	INTERNAL TIMBER DOOR			
11	820	CAVITY SLIDING DOOR			
12	820	CAVITY SLIDING DOOR			
13	1040	LINEN CUPBOARD DOORS BY BUILDER			
14	920	EXTERNAL SOLID DOOR			

FIRST FLOOR DOOR SCHEDULE					
MARK	MIDTH	TYPE	REMARKS		
15	870	INTERNAL TIMBER DOOR			
16	820	CAVITY SLIDING DOOR			
17	820	CAVITY SLIDING DOOR			
18	820	CAVITY SLIDING DOOR			
19	870	INTERNAL TIMBER DOOR			
30	1200	DOORWAY -FRAME, NO DOOR			
31	920	DOORWAY -FRAME, NO DOOR			

ALUMINIUM WINDOWS DOUBLE GLAZING COMPLETE WITH FLY SCREENS TO SUIT BAL-19 RATING. ALL WINDOW MEASUREMENTS TO BE VERIFIED ON SITE PRIOR TO ORDERING

	GROUND FLOOR WINDOW SCHEDULE						
MARK	HEIGHT	MIDTH	TYPE	REMARKS			
M 1	1800	2400	AMNING MINDOM				
M2	1800	2400	AMNING MINDOM				
M3	1800	2400	AMNING MINDOM				
M4	900	910	AMNING MINDOM	LOUVERS AS ALTERNATIVE TO OPAQUE			
M5	1800	2400	AMNING MINDOM				
M6	2100	3010					
M7	1000	1810	AMNING MINDOM	LOUVERS AS ALTERNATIVE TO OPAQUE			
MS	1800	910	AMNING MINDOM	LOUVERS AS ALTERNATIVE TO OPAQUE			
M9	2100	2110	SLIDING DOOR				
W10	900	2410	AMNING MINDOM				

	FIRST FLOOR WINDOW SCHEDULE					
MARK	HEIGHT	MIDTH	TYPE	REMARKS		
M11	1200	1210	AMNING MINDOM			
M12	1200	2600	FIXED MINDOM			
M13	1200	1200	FIXED CORNER MINDOM			
M14	1800	2400	AMNING MINDOM			
M15	1800	2400	AMNING MINDOM			
M16	2100	2710	STACKING SLIDING DOOR			
M17	2100	2100	FIXED MINDOM			
M18	2100	2710	STACKING SLIDING DOOR			
M19	2100	2100	SLIDING DOOR			
M20	600	2410	AMNING MINDOM			
M21	1200	1210	AMNING MINDOM			
M22	1200	1210	AMNING MINDOM	LOUVERS AS ALTERNATIVE TO OPAQUE		
M23	900	610	AMNING MINDOM	LOUVERS AS ALTERNATIVE TO OPAQUE		



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Project:
PROPOSED NEW RESIDENCE
7-11 FRESHWATER STREET,
BEAUMARIS

Client name:

R. & E. MURPHY

Drafted by: Approved by: J.M Approver BUILDING DESIGNERS ASSOCIATION OF AUSTRALIA

Drawing: DOOR AND WINDOW SCHEDULES

Date: Scale:


20.10.2025

Project/Drawing no: Revision: PD25023 -06 06

EASTERN ELEVATION

1:100

1:100

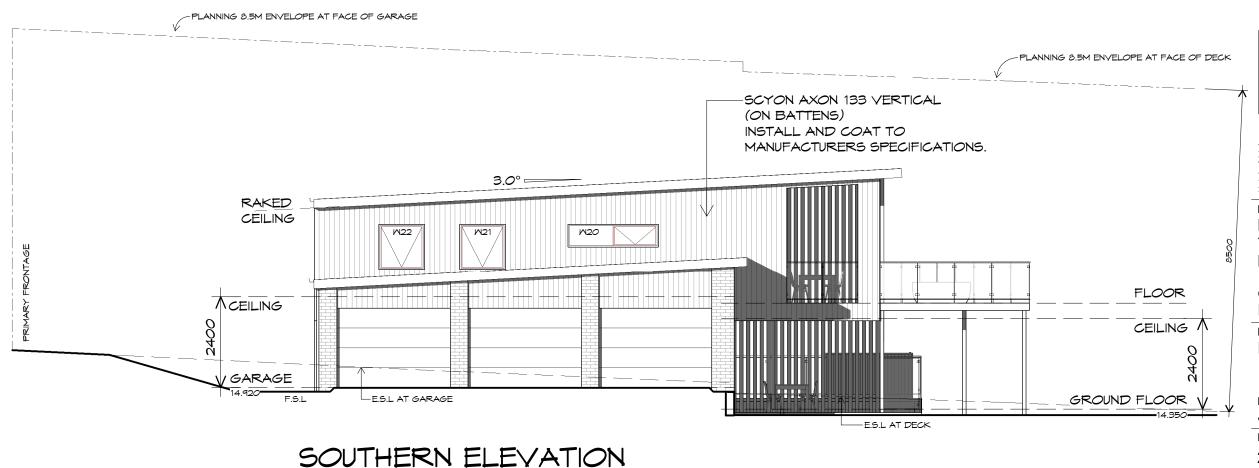



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PROPOSED NEW RESIDENCE 7-11 FRESHWATER STREET, **BEAUMARIS**


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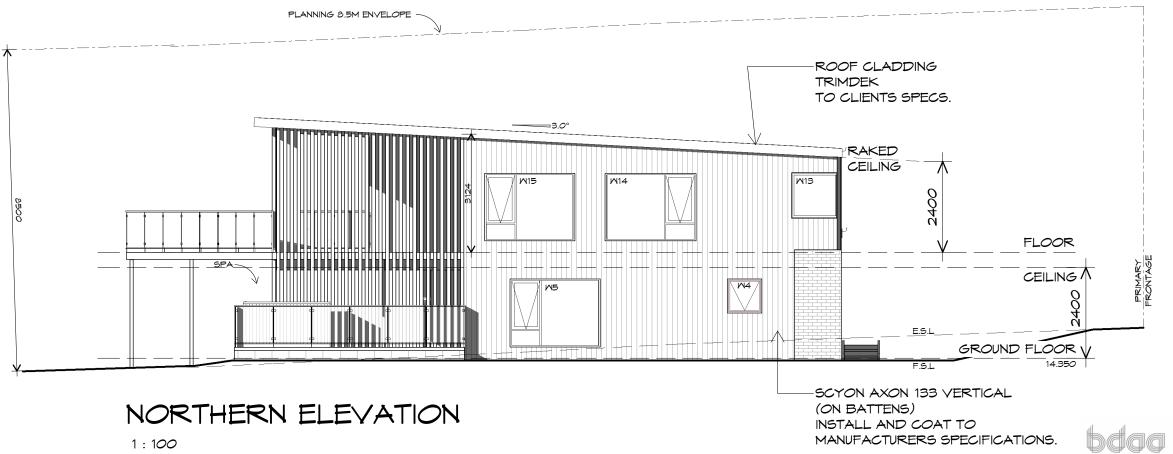
R. & E. MURPHY

Drawing:

ELEVATIONS

Drafted by: J.M	Approved by: Approver	
Date:	Scale:	
20.10.2025	1:100	
Project/Drawing no:		Revision:
PD25023 -07		06



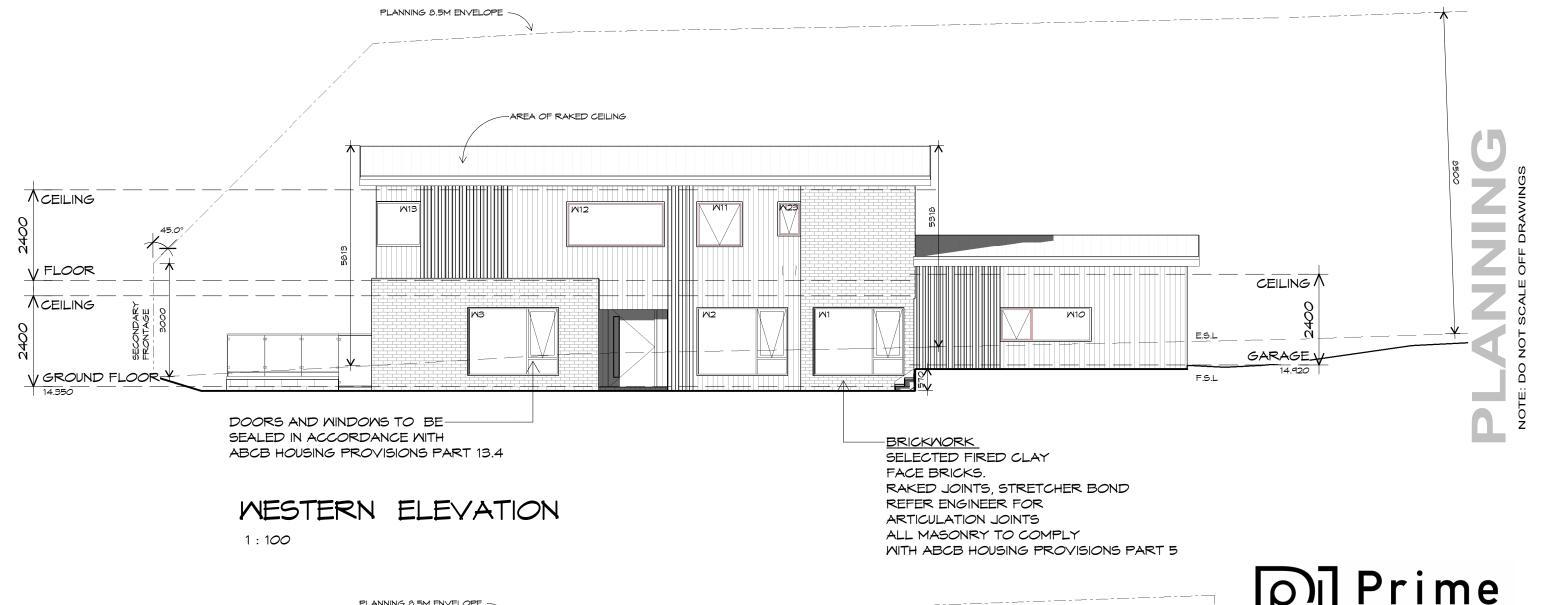



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Proje

PROPOSED NEW RESIDENCE 7-11 FRESHWATER STREET, BEAUMARIS

Client name:

R. & E. MURPHY

Drawing:

ELEVATIONS

	Drafted by: J.M	Approved by: Approver	
	Date:	Scale:	
	20.10.2025	1:100	
	Project/Drawing no:	Revision:	
	PD25023 -08	06	
_			

UILDING DESIGNERS

NG DESIGNERS

ROOF PLUMBING NOTES:

GUTTER INSTALLATION
TO BE IN ACCORDANCE WITH
ABCB HOUSING PROVISIONS PART 7.4.4
WITH FALL NO LESS THAN
1:500 FOR EAVES GUTTER
BOX GUTTERS IN ACCORDANCE WITH
AS33500.3:2021

UNLESS FIXED TO METAL FASCIA EAVES GUTTER TO BE FIXED @ 1200 CRS MAX.

VALLEY GUTTERS ON A ROOF WITH A PITCH:

A) MORE THAN 12.5° DEGREES - MUST
HAVE A WIDTH OF NOT LESS THAN
400mm AND ROOF OVERHANG OF NOT
LESS THAN 150mm EACH SIDE OFVALLEY
GUTTER.

B) LESS THAN 12.5° DEGREES, MUST BE
DESIGNED AS A BOX GUTTER.

LAP GUTTERS 75MM IN THE DIRECTION OF FLOW, RIVET & SEAL WITH AN APPROVED SILICONE SEALANT.

DOWNPIPE POSITIONS SHOWN ON THIS PLAN ARE NOMINAL ONLY.

EXACT LOCATION & NUMBER OF D.P'S REQUIRED ARE TO BE IN ACCORDANCE WITH ABCB HOUSING PROVISIONS PART 7.4.5 REQUIREMENTS.


SPACING BETWEEN DOWNPIPES MUST NOT BE MORE THAN 12M & LOCATED AS CLOSE AS POSSIBLE TO VALLEY GUTTERS

METAL ROOF

METAL SHEETING ROOF TO BE INSTALLED IN ACCORDANCE WITH ABCB HOUSING PROVISIONS PART 7.2. REFER TO TABLE 7.2.2a FOR ACCEPTABLE CORROSION PROTECTION FOR SHEET ROOFING, REFER TO TABLE 7.2.2b-7.2.2e FOR ACCEPTABILITY OF CONTACT BETWEEN DIFFERENT ROOFING MATERIALS. FOR FIXING, SHEET LAYING SEQUENCE, FASTENER FREQUENCY FOR TRANVERSE FLASHINGS AND CAPPINGS, ANTI CAPILLARY BREAKS, FLASHING DETAILS REFER TO ABCB HOUSING PROVISIONS PART 7.2.5-7.2.7. ROOF PENETRATION FLASHING DETAILS. REFER TO TO ABCB HOUSING PROVISIONS PART 7.2.5-7.2.7. ROOF SHEETING MUST OVERHANG MIN 35MM AS PER ABCB HOUSING PROVISIONS PART 7.2.8

ADDITIONAL ROOF LOAD

NO SOLAR P.V. SYSTEM HAS BEEN ALLOWED FOR, NO SOLAR HOT WATER HAS BEEN ALLOWED FOR.

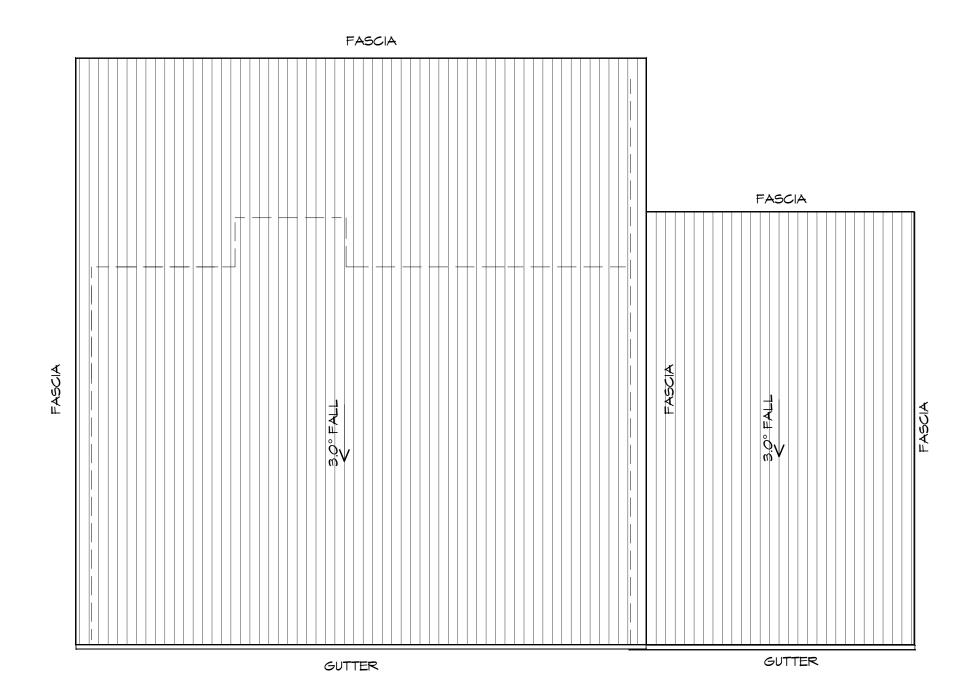

ROOF PLAN

1:100



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p(h)+ 03 6228 4575 info@primedesigntas.com.au primedesigntas.com.au

Drafted by: Approved by:

Approver

Drawing: ROOF PLAN

Client name:
R. & E. MURPHY

BEAUMARIS

PROPOSED NEW RESIDENCE

7-11 FRESHWATER STREET,


BUILDING DESIGNERS


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Project/Drawing no: Revision: PD25023 -09 06


Accredited building practitioner: Frank Geskus -No CC246A

NOT



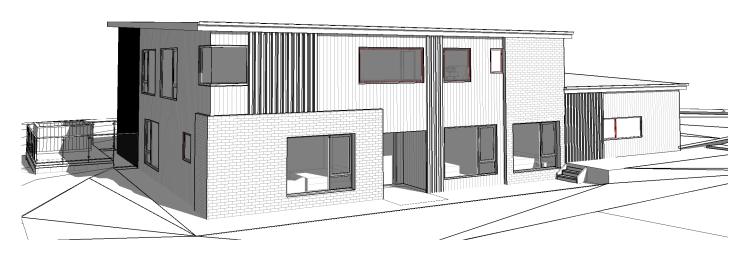

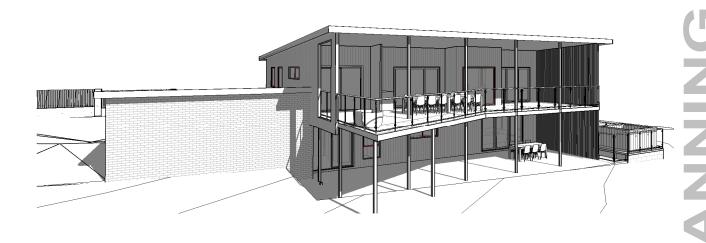FENCE NOT SHOWN FOR CLARITY

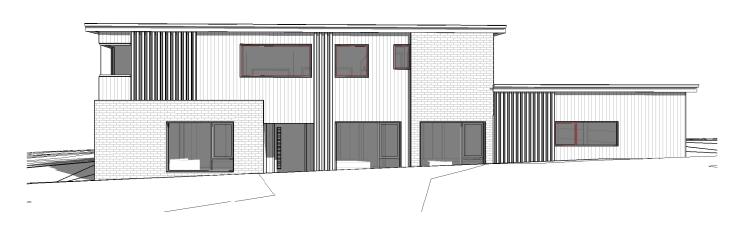

FENCE NOT SHOWN FOR CLARITY



Prime Design

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Project:
PROPOSED NEW RESIDENCE
7-11 FRESHWATER STREET,
BEAUMARIS

Client name:

R. & E. MURPHY

Drafted by: J.M

Approved by: Approver

Drawing: PERSPECTIVES

Date: Scale:

20.10.2025

Project/Drawing no: Revision: PD25023 -10 06



20 October 2025

Break O'Day Council 32-34 Georges Bay Esplanade St Helens, Tasmania 7216 e: admin@bodc.tas.gov.au t: 03 6376 7900

Dear Alex,

Re: Proposed New Residence, 7-11 Freshwater Street, Beaumaris

The proposal is for new residence at 7-11 Freshwater Street, Beaumaris in an area zoned low density residential.

This design response will address the development standards outlining any discretionary elements.

10.4.2 Building Height

A1 Complies with a building height of not more than 8.5m. Refer to elevations for planning envelope.

10.4.3 Setbacks

- A1 Does not comply. The proposed residence does not have a front setback greater than 8m from the northern corner boundary abutting Freshwater Street.
- P1 The siting of a dwelling must be compatible with the streetscape and character of development existing on established properties in the area.

The proposed residence is set appropriately within the topography of the site. The floor level is modest & gives consideration to the surrounding properties in the subdivision. Any cut to the site is battered with no impact to the streetscape & will be landscaped for best visual appearance from Freshwater Street.

The proposed setback of the residence is consistent with setbacks of surrounding buildings in the subdivision. Existing residences & corner lots within the immediate area demonstrate significantly reduced setbacks. From the primary frontage, the acceptable solution of an 8m setback is met. The slightly reduced 5m setback to the Northern boundary is compatible with the surrounding streetscape.

The height, bulk & form of the proposed residence is of a similar nature to existing buildings in the area. Existing residences within Freshwater Street provide reduced setback precedent for the bulk & form of double story buildings. As mentioned above,

the floor level of the house is set respectively, reducing the height when viewed streetscape.

The appearance of the proposed residence when viewed from Freshwater Street & public open space is compatible with the character of established properties. Perspectives included within the drawing set demonstrate how the development will be viewed from the streetscape.

The reduced setback to the Northern corner does not impact the safety of road users.

C2.6.1 Construction of Parking Areas

A1 Complies. The proposed concrete driveway meets the acceptable solution of the code. Any stormwater from the driveway is directed by fall to a grated trench in front of the garage door. The water collected by the trench, drains into a pit specified, from which the stormwater runoff from the driveway is then directed to the stormwater connection on the property. The site drainage plan can be referenced for clarification.

BRE-S2.7.1 Stormwater Management

A1 Complies. The proposed residence is capable of connecting to the existing stormwater connection to the property, located by East Coast Surveying.

All water collected by the roof area will be captured & stored in tanks to the rear of the property. Any overflow will be appropriately discharged to the stormwater infrastructure located in the drainage easement.

As noted on the site drainage plan, any water associated with the swim spa will be discharged & dispersed within the boundaries of the site. Noting, per council guidance any water discharge occurring during a water change is not able to connect to the stormwater connection or wastewater system

10.4.5 Front Fences for all Dwellings

P1 The proposed fence to replace the existing post & wire comprises of 0.6m of brickwork to the base with 1.2m of vertical fencing above to a total height of 1.8m. The proposed fence provides security & privacy to the residence whilst allowing for passive surveillance of the road. The adjoining property fence at 13 Freshwater is constructed of caged rock to an assumed height of 1.8m. Comparatively, the proposed fence at 7-11 Freshwater provides a greater level of transparency & is more than reasonable for traffic volumes of the adjoining road. As demonstrated in the concept diagram below, the proposed brickwork & vertical fencing is appropriate for the topography of the site & the fence follows the contours respectfully. The style of proposed fencing is similar to that of 15 Freshwater & compliments the streetscape. Furthermore, the proposed fence compliments the proposed new residence & development on the site.


Image of existing post & wire fence:



Existing street boundary fence to be replaced:



Diagram of proposed fence:

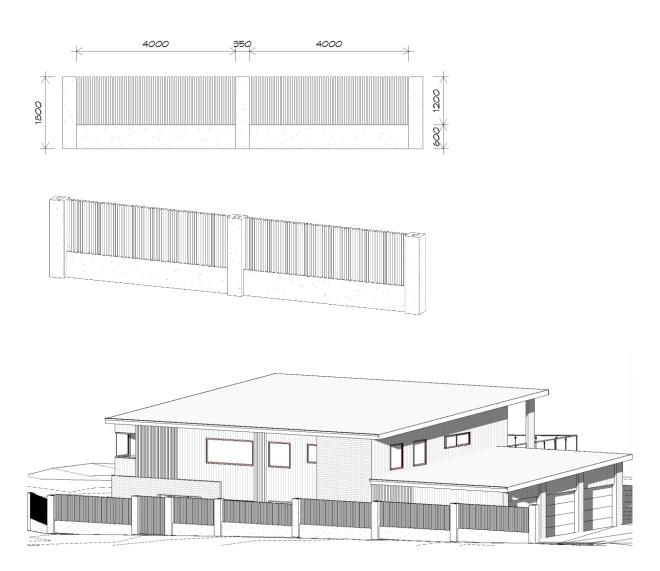

Freshwater Street Fencing Precedent:


Realestate Image



Realestate Image





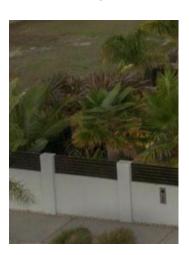

Materials: Wire, Stone, Timber, Brickwork Rendered Assumed height of 1500mm – 1800mm

Kind Regards,

J Medwin

Jessie Medwin