32-34 Georges Bay Esplanade St Helens Tasmania 7216 T: 03 6376 7900 ABN 96 017 131 248



Development Applications

Notice is hereby given under Section 57(3) of the Land Use Planning & Approvals Act 1993 that an application has been made to the Break O' Day Council for a permit for the use or development of land as follows:

DA Number DA 2025 / 00145 **Applicant Engineering Plus**

Proposal Residential - Retrospective Approval of Dwelling

Location 31 Hills Road, St Helens

Plans and documents can be inspected at the Council Office by appointment, 32 - 34 Georges Bay Esplanade, St Helens during normal office hours or online at www.bodc.tas.gov.au.

Representations must be submitted in writing to the General Manager, Break O'Day Council, 32 -34 Georges Bay Esplanade, St Helens 7216 or emailed to admin@bodc.tas.gov.au, and referenced with the Application Number in accordance with section 57(5) of the abovementioned Act during the fourteen (14) day advertised period commencing on Saturday 22nd November, 2025 until 5pm Friday 5th December, 2025.

John Brown **GENERAL MANAGER**



DRAWING SCHEDULE

A00 COVER PAGE

A01 SITE SURROUNDINGS PLAN

A02 SITE PLAN

A03 CONSTRUCTION PLAN

A04 FLOOR PLAN

A05 ELEVATIONS #1

A06 AREA PLAN

A07 3D PERSPECTIVE #1 A08 3D PERSPECTIVE #2

A09 3D PERSPECTIVE #3

A10 3D PERSPECTIVE #4

PROJECT INFORMATION

BUILDING DESIGNER: GRANT JAMES PFEIFFER

ACCREDITATION No: CC2211T

ZONE: 11.0 RURAL LIVING ZONE

BUILDING CLASS: CLASS 1
LAND TITLE REFERENCE NUMBER: 230150/1

DESIGN WIND SPEED:

SOIL CLASSIFICATION:

ASSUMED "N3"
ASSUMED "H1"

CLIMATE ZONE: 7

BUSHFIRE-PRONE BAL RATING: TBA ALPINE AREA: N/A

CORROSION ENVIRONMENT:

FLOODING:

LANDSLIP:

LOW

DISPERSIVE SOILS: UNKNOWN SALINE SOILS: UNKNOWN

SAND DUNES:

MINE SUBSIDENCE:

LANDFILL:

NO

GROUND LEVELS: REFER PLAN

ORG LEVEL: 75mm ABOVE GROUND LEVEL

AS CONSTRUCTED DWELLING


M . PYKE 31, HILLS ROAD ST HELENS TAS 7216

BREAK O'DAY COUNCIL

ISSUED FOR DEVELOPMENT APPROVAL


DEVELOPMENT AREA			
Name	Area		
AS CONSTRUCTED BATHROOM	11.36 m²		
AS CONSTRUCTED BEDROOM	10.84 m²		
AS CONSTRUCTED DECK	12.71 m²		
AS CONSTRUCTED EN-SUITE	3.28 m²		
AS CONSTRUCTED KITCHEN + DINING	17.25 m²		
AS CONSTRUCTED LIVING	15.02 m²		
AS CONSTRUCTED LOUNGE ROOM	11.16 m²		
AS CONSTRUCTED WALK IN ROBE	8.03 m ²		

89.64 m²

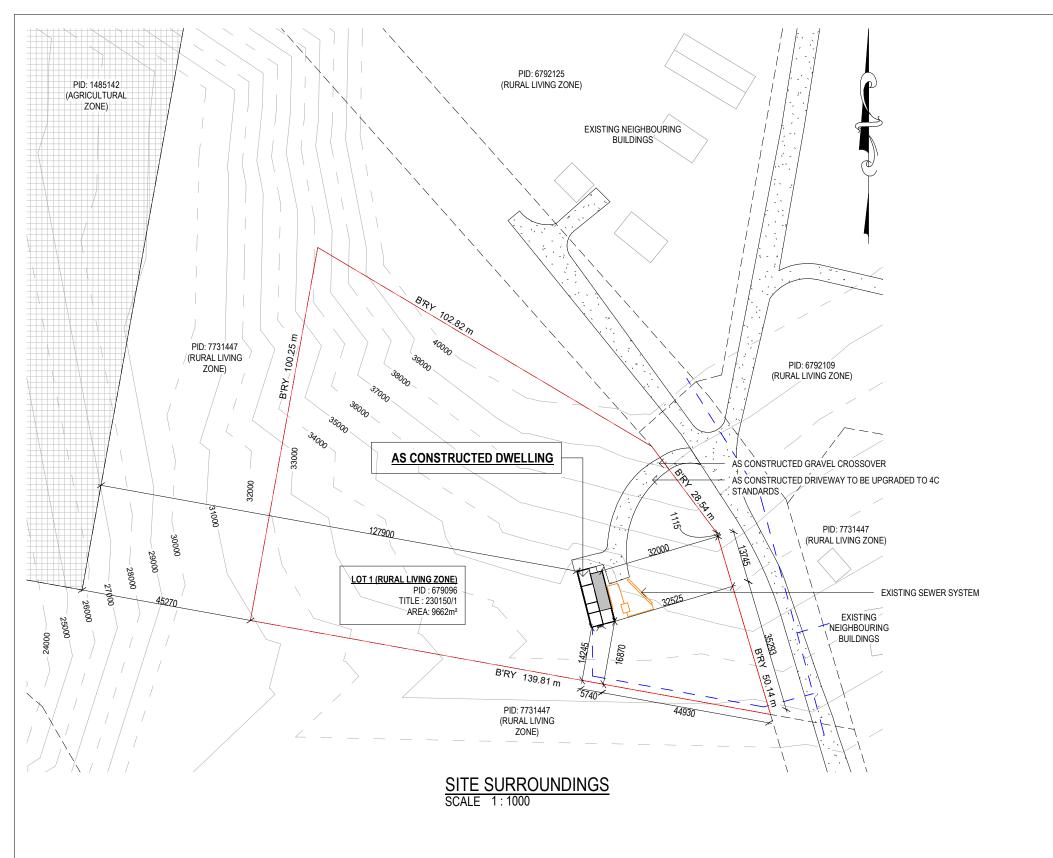





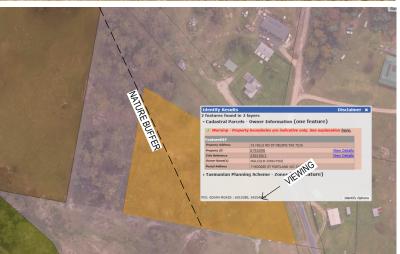

DRAINAGE

ALL DRAINAGE WORK SHOWN IS PROVISIONAL ONLY AND IS SUBJECT TO AMENDMENT TO COMPLY WITH THE REQUIREMENTS OF THE LOCAL AUTHORITIES. ALL WORK IS TO COMPLY WITH THE REQUIREMENTS OF NATIONAL PLUMBING AND DRAINAGE CODE AS3500 AND MUST BE CARRIED OUT BY A LICENCED TRADESMAN ONLY.

STORMWATER FROM AS CONSTRUCTED DWELLING TO BE DIRECTED INTO EXISTING STORMWATER SYSTEM TO LOCAL COUNCIL REQUIREMENTS & AS3500

ENTIRETY OF THE PROPERTY IS LOCATED IN A BUSHFIRE PRONE ZONE

<u>LEGEND</u>			
	SEWER		
	WATER		
	STORMWATER		
	AGRICULTURE ZONE		

R.F.I NOTES: 11.0 RURAL LIVING ZONE

11.4.2 BUILDING HEIGHHT, SETBACK AND SITING - PLEASE NOTE THAT ASSESSMENT WILL BE REQUIRED AGAINST PERFORMANNCE CRITERIA P4 AS THE DWELLING WILL BE LOCATED LESS THAN 200m TO A PROPERTY SUBJECT TO THE 21.0 AGRICULTURE ZONE.

THE AS-CONSTRUCTED DWELLING IS LOCATED APPROXIMATELY 127,900 MM (127.9 M) FROM THE AGRICULTURE ZONE. ON PLOT 7731447, THÈRE IS Á BELT OF MATURE TREES APPROXIMATELY 45,270 MM (45.27 M) WIDE SEPARATING THE PROPERTY. THIS VEGETATION PROVIDES A NATURAL BARRIER BETWEEN THE AGRICULTURE ZONE AND THE AS-CONSTRUCTED DWELLING, THEREBY MINIMISING ANY POTENTIAL IMPACT ON THE AGRICULTURAL ZONE.

THE DWELLING IS SITUATED ON A SLOPING AREA, POSITIONED WELL AWAY FROM THE AGRICULTURE ZONE, AND WILL NOT INTERFERE WITH THE AGRICULTURE ZONE.

THE ABSORPTION TRENCH AND SEPTIC TANK ARE LOCATED ON THE OPPOSITE SIDE OF THE DWELLING, FACING AWAY FROM THE AGRICULTURE ZONE. THIS PLACEMENT FURTHER ENSURES THAT THERE WILL BE NO ADVERSE IMPACT ON THE NEIGHBOURING AGRICULTURAL LAND.

R.F.I UPDATES

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Client: M. PYKE

Project: AS CONSTRUCTED DWELLING

Address:31 HILLS ROAD

ST HELENS TAS 7216

ENGINEERING

Drawing No:

20424 A01 / A10 Rev

В

DEVELOPMENT APPROVAL 27.10.25 J.C Checked: J. Pfeiffer DEVELOPMENT APPROVAL 11.09.25 J.C Approved: J. Pfeiffer ISSUED FOR REVIEW 24.07.25 J.C Scale: As Shown @ A3 ISSUED FOR REVIEW 15.07.25 J.C ISSUED FOR REVIEW Rev: Amendment:

Accredited Building Designer 06.06.25 J.C | Designer Name: J.Pfeiffer Date: Int: Accreditation No: CC2211T

Date Drawn: 06.06.25

Drawn: J. Chin

-MAXIMUM GRADIENT OF 15° (1:3.5 OR 28%) FOR SEALED ROADS, AND 10° (1:5.5 OR 18%) FOR UNSEALED ROADS; AND -TERMINATE WITH A TURNING AREA FOR FIRE APPLIANCES PROVIDED BY ONE OF THE FOLLOWING: -A TURNING CIRCLE WITH A MINIMUM INNER RADIUS OF 10 METRES; -A PROPERTY ACCESS ENCIRCLING THE BUILDING; OR -A HAMMERHEAD "T" OR "Y" TURNING HEAD 4 METRES WIDE AND 8 METRES LONG.

A MODIFIED 4C ACCESS ROAD IS AN ALL-WEATHER ROAD WHICH COMPLIES WITH THE AUSTRALIAN ROAD RESEARCH BOARD

"UNSEALED ROADS MANUAL - GUIDELINES TO GOOD PRACTICE", 3RD EDITION, MARCH 2009 AS A CLASSIFICATION

4C ACCESS ROAD AND THE FOLLOWING MODIFIED REQUIREMENTS:

-DIPS LESS THAN 7° (1:8 OR 12.5%) ENTRY AND EXIT ANGLE;

-CURVES WITH A MINIMUM INNER RADIUS OF 10 METRES;


-MINIMUM CARRIAGEWAY WIDTH OF 4 METRES:

-MINIMUM VERTICAL CLEARANCE OF 4 METRES


-CROSS FALLS OF LESS THAN 3° (1:20 OR 5%);

-ALL-WEATHER CONSTRUCTION; -LOAD CAPACITY OF AT LEAST 20 TONNES, INCLUDING FOR BRIDGES AND CULVERTS;

-MINIMUM HORIZONTAL CLEARANCE OF 0.5 METRES FROM THE EDGE OF THE CARRIAGEWAY;

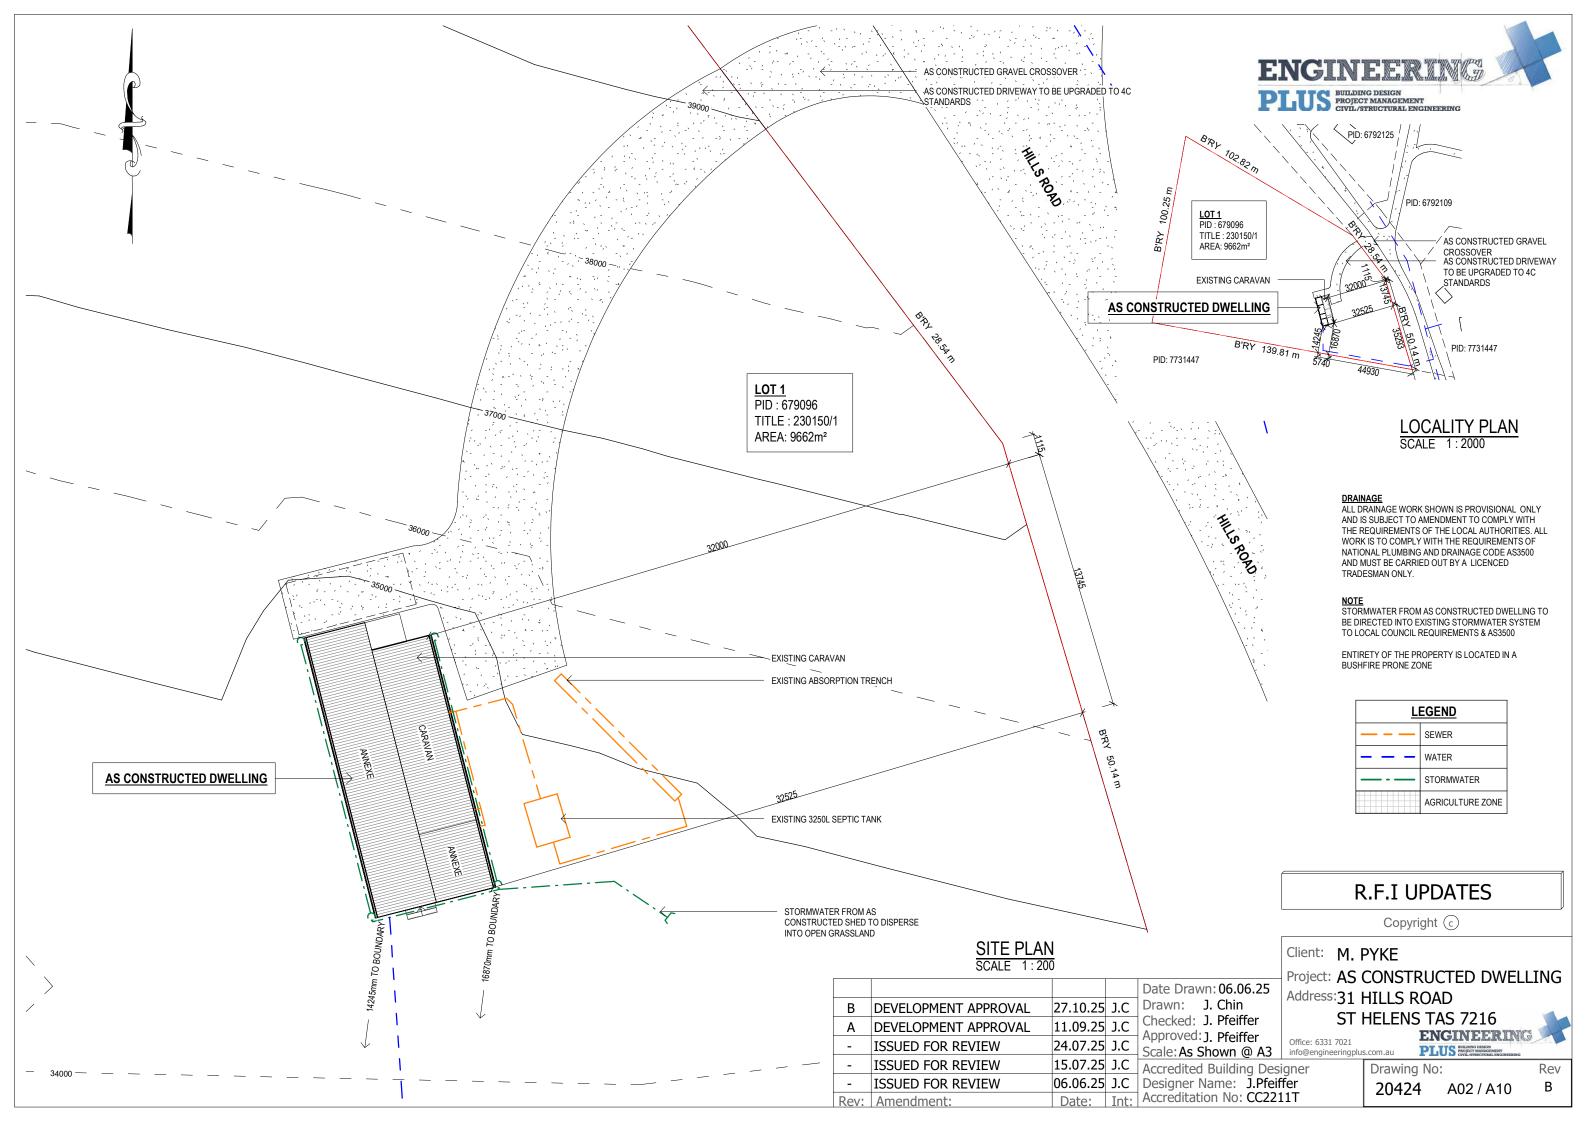



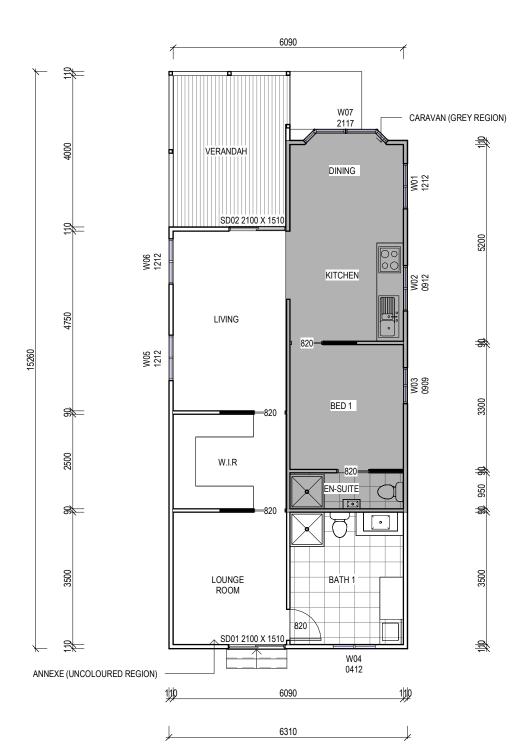

CONSTRUCTION FLOOR PLAN SCALE 1:100

Area Schedule (Gross Building)			
Name	Area	Area (sq)	
AS CONSTRUCTED BATHROOM	11.36 m²	1.22	
AS CONSTRUCTED BEDROOM	10.84 m²	1.17	
AS CONSTRUCTED DECK	12.71 m²	1.37	
AS CONSTRUCTED EN-SUITE	3.28 m²	0.35	
AS CONSTRUCTED KITCHEN + DINING	17.25 m²	1.86	
AS CONSTRUCTED LIVING	15.02 m²	1.62	
AS CONSTRUCTED LOUNGE ROOM	11.16 m²	1.20	
AS CONSTRUCTED WALK IN ROBE	8.03 m ²	0.86	
	89.64 m²	9.65	



WINDOW SCHEDULE

MARK	HEIGHT	WIDTH	TYPE	U-VALUE	SHGC
W1	1200	1200	DG	4.3	0.55
W2	900	1500	DG	4.3	0.55
W3	900	950	DG	4.3	0.55
W4	400	1200	DG	4.3	0.55
W5	1200	1200	DG	4.3	0.55
W6	1200	1200	DG	4.3	0.55
W7	2100	1700	DG	4.3	0.55
SD1	2100	1510	DG	4.0	0.61
SD2	2100	1510	DG	4.0	0.61

DISCLAIMER

ALL WINDOWS SHOWN ON PLAN ARE APPROX. BASED OFF STANDARD MANUFACTURING SIZES. ALL WINDOW DIMENSIONS TO BE CONFIRMED ON SITE BY BUILDER PRIOR TO ORDERING AND MANUFACTURING.

* - IF HEIGHT TO GROUND IS GREATER THAN 2.0m WINDOW TO HAVE PERMANENTLY FIXED ROBUST SCREEN INSTALLED OR HAVE AN OPENING RESTRICTED TO 125mm

11.09.25 J.C

24.07.25 J.C

B DEVELOPMENT APPROVAL

A DEVELOPMENT APPROVAL

ISSUED FOR REVIEW

ISSUED FOR REVIEW

ISSUED FOR REVIEW

Rev: Amendment:

27.10.25 J.C Drawn: J. Chin

R.F.I UPDATES

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Client: M. PYKE

Project: AS CONSTRUCTED DWELLING

Address:31 HILLS ROAD

ST HELENS TAS 7216 ENGINEERING

Scale: As Shown @ A3 info@engineeringplus.com.au

Drawing No:

20424 A03 / A10

15.07.25 J.C Accredited Building Designer 06.06.25 J.C | Designer Name: J.Pfeiffer Date: Int: Accreditation No: CC2211T


Date Drawn: 06.06.25

Checked: J. Pfeiffer

Approved: J. Pfeiffer

В

Rev

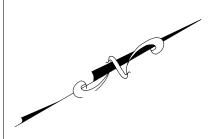





FLOOR	FLOOR COVERINGS		
	CARPET		
- A A	CONCRETE		
	TIMBER DECKING		
	TILE		
	VINYL TIMBER FLOORING		

SMOKE ALARMS
PROVIDE AND INSTALL SMOKE ALARMS & HARD WIRE
TO BUILDING POWER SUPPLY TO AS 3786. CEILING MOUNTED WITH 9VDC ALKALINE BATTERY BACKUP TO LOCATIONS INDICATED ON PLAN AND IN ACCORDANCE WITH ABCB OF H3D6 - PART 9.5.2

(S) - DENOTES INTERCONNECTED SMOKE DETECTORS

Area Schedule (Gross Building) Name Area Area (sq) AS CONSTRUCTED BATHROOM 11.36 m² 1.22 1.17 AS CONSTRUCTED BEDROOM 10.84 m² AS CONSTRUCTED DECK 12.71 m² 1.37 AS CONSTRUCTED EN-SUITE 3.28 m² 0.35 AS CONSTRUCTED KITCHEN + DINING 17.25 m² 1.86 AS CONSTRUCTED LIVING 15.02 m² 1.62 AS CONSTRUCTED LOUNGE ROOM 11.16 m² 1.20 AS CONSTRUCTED WALK IN ROBE 8.03 m² 0.86 89.64 m² 9.65

R.F.I UPDATES

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Client: M. PYKE

Project: AS CONSTRUCTED DWELLING

Address:31 HILLS ROAD

ST HELENS TAS 7216

ENGINEERING PLUS BUILDING DESIGN
PROJECT MANAGEMENT
CIVIL/STRUCTURAL ENGIN

15.07.25 J.C Accredited Building Designer 06.06.25 J.C | Designer Name: J.Pfeiffer

Date Drawn: 06.06.25

Checked: J. Pfeiffer

Date: Int: Accreditation No: CC2211T

27.10.25 J.C Drawn: J. Chin

11.09.25 J.C

24.07.25 J.C

B DEVELOPMENT APPROVAL

A DEVELOPMENT APPROVAL

ISSUED FOR REVIEW

ISSUED FOR REVIEW

ISSUED FOR REVIEW

Rev: Amendment:

Approved: J. Pfeiffer
Scale: As Shown @ A3

Office: 6331 7021
info@engineeringplus.com.au

Drawing No:

20424 A04 / A10

Rev


SELECTED ALUMINIUM FRAMED WINDOWS - ABCB VOLUME 2 PART 8.3

POWDER COATED ALUMINIUM WINDOW & DOOR FRAMES, UNLESS OTHERWISE NOTED.

TASMANIAN OAK REVEALS AND TRIMS. ALL FLASHING AND FIXINGS TO MANUFACTURERS SPECIFICATIONS.


GLAZING & FRAME CONSTRUCTION TO AS 2047 & AS 1288


ALL FIXINGS AND FLASHINGS TO MANUFACTURERS REQUIREMENTS

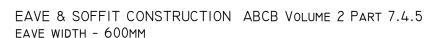



SOFFIT / EAVE LINED WITH 'HARDIFLEX' CEMENT SHEETING

- TRIMMERS LOCATED WITHIN 1200 MM OF EXTERNAL CORNERS TO BE SPACED @ 500 MM CENTERS, REMAINDER OF SHEET 700 MM CENTERS
- FASTENER / FIXINGS WITHIN 1200 MM OF EXTERNAL CORNERS @ 200 MM CENTERS, REMAINDER OF SHEET 300 MM CENTERS

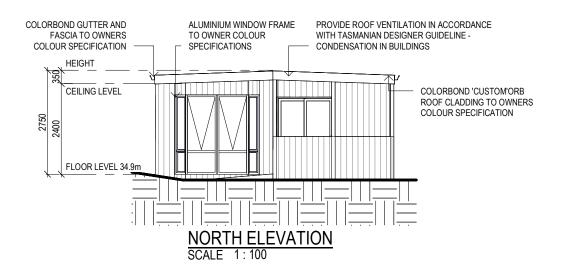

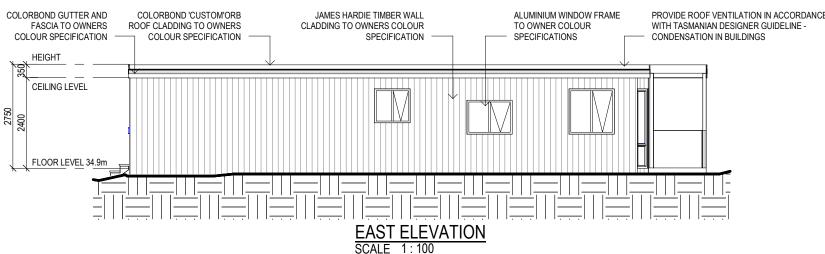

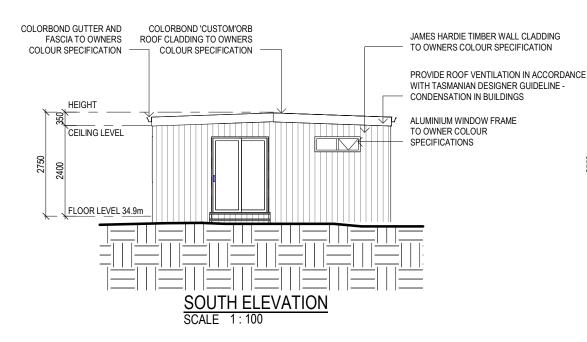

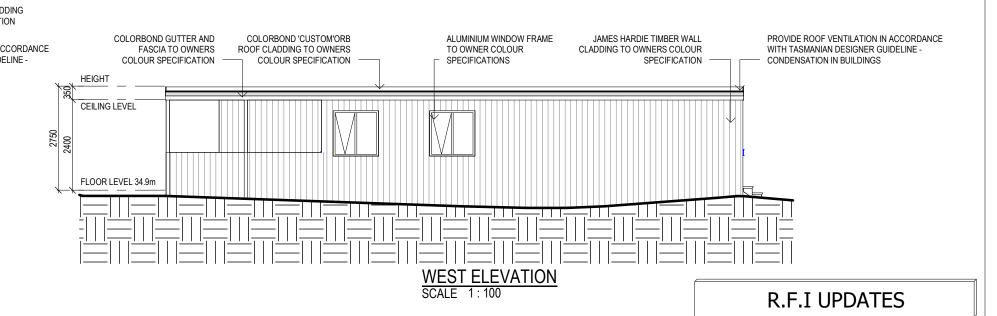

SUB FLOOR VENTILATION. NCC VOL 2 PART 6.2.1

- A MINIMUM OF 150 MM OF SUB FLOOR CLEARANCE IS TO BE PROVIDED BETWEEN FINISHED SURFACE LEVEL & THE UNDERSIDE OF THE FLOOR BEARER.
- A MINIMUM OF 6000 MM2 PER METRE OF SUB FLOOR VENTILATION IS TO BE UNIFORMLY DISTRIBUTED AROUND THE EXTERNAL AND INTERNAL WALLS OF THE BUILDING
- VENTS TO BE LOCATED NO GREATER THAN 600 MM FROM AN INTERNAL OR EXTERNAL CORNER.

PRYDA 230x75 - 52 HOLE VENT MAXIMUM SPACING 1050 MM ALONG WALL OR PRYDA 230x165 - 117 HOLE VENT MAXIMUM SPACING 2350 MM ALONG WALL

ADDITIONAL VENTILATION PROVISIONS TO BE INSTALLED WHERE OBSTRUCTIONS SUCH AS CONCRETE VERANDAH'S, DECKS, PATIOS AND PAVING ARE INSTALLED & OBSTRUCT VENTILATION.

					Proje
				Date Drawn: 06.06.25	Addr
В	DEVELOPMENT APPROVAL	27.10.25	J.C	I .	Addi
Α	DEVELOPMENT APPROVAL	11.09.25			
-	ISSUED FOR REVIEW	24.07.25			Office: info@e
-	ISSUED FOR REVIEW	15.07.25			
-	ISSUED FOR REVIEW	06.06.25	J.C	Designer Name: J.Pfeif	fer
Rev:	Amendment:	Date:	Int:	Accreditation No: CC221	L1T
	A - -	A DEVELOPMENT APPROVAL - ISSUED FOR REVIEW - ISSUED FOR REVIEW	A DEVELOPMENT APPROVAL 11.09.25 - ISSUED FOR REVIEW 24.07.25 - ISSUED FOR REVIEW 15.07.25 - ISSUED FOR REVIEW 06.06.25	A DEVELOPMENT APPROVAL 11.09.25 J.C - ISSUED FOR REVIEW 24.07.25 J.C - ISSUED FOR REVIEW 15.07.25 J.C - ISSUED FOR REVIEW 06.06.25 J.C	B DEVELOPMENT APPROVAL 27.10.25 J.C A DEVELOPMENT APPROVAL 11.09.25 J.C - ISSUED FOR REVIEW 24.07.25 J.C - ISSUED FOR REVIEW 15.07.25 J.C - ISSUED FOR REVIEW 06.06.25 J.C Drawn: J. Chin Checked: J. Pfeiffer Approved: J. Pfeiffer Scale: As Shown @ A3 - Accredited Building Designer Name: J. Pfeiffer Scale: As Shown @ Designer Name: J. Pfeiffer Scale: As Shown @ A3

Client: M. PYKE te Drawn: 06.06.25

Project: AS CONSTRUCTED DWELLING

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Address:31 HILLS ROAD ST HELENS TAS 7216

Office: 6331 7021


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PROJECT MANAGEMENT
GIVIL/STRUCTURAL ENGI

info@engineeringplus.com.a

Drawing No:


20424 A05 / A10

Rev В

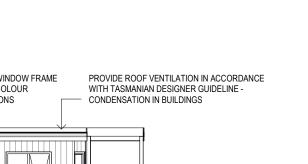

BUILDING DESIGN PROJECT MANAGEMENT



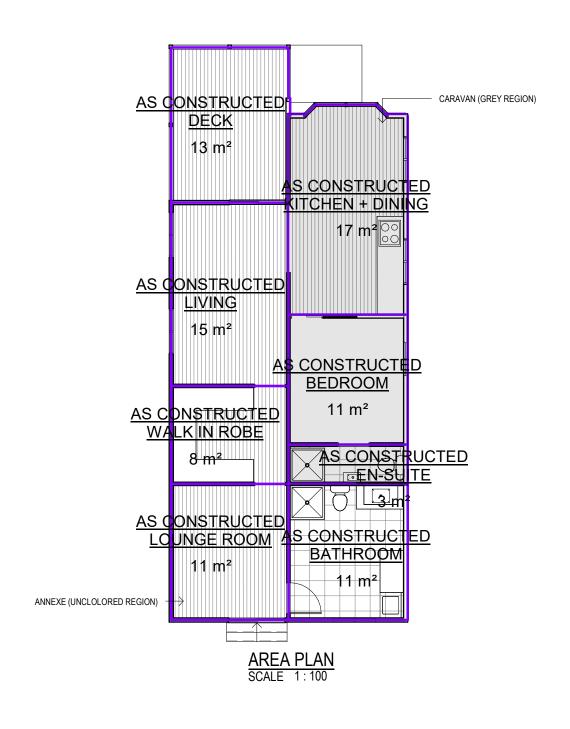

Area Schedule (Gross Building)			
Name	Area	Area (sq)	
AS CONSTRUCTED BATHROOM	11.36 m²	1.22	
AS CONSTRUCTED BEDROOM	10.84 m²	1.17	
AS CONSTRUCTED DECK	12.71 m²	1.37	
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AS CONSTRUCTED WALK IN ROBE	8.03 m ²	0.86	
	89 64 m²	9 65	

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ST HELENS TAS 7216

ENGINEERING

Approved: J. Pfeiffer Scale: As Shown @ A3

Office: 6331 7021 info@engineeringplus.com.au 15.07.25 J.C Accredited Building Designer

Date Drawn: 06.06.25

27.10.25 J.C Drawn: J. Chin

11.09.25 J.C Checked: J. Pfeiffer

06.06.25 J.C Designer Name: J.Pfeiffer

Date: Int: Accreditation No: CC2211T

B DEVELOPMENT APPROVAL

A DEVELOPMENT APPROVAL

ISSUED FOR REVIEW

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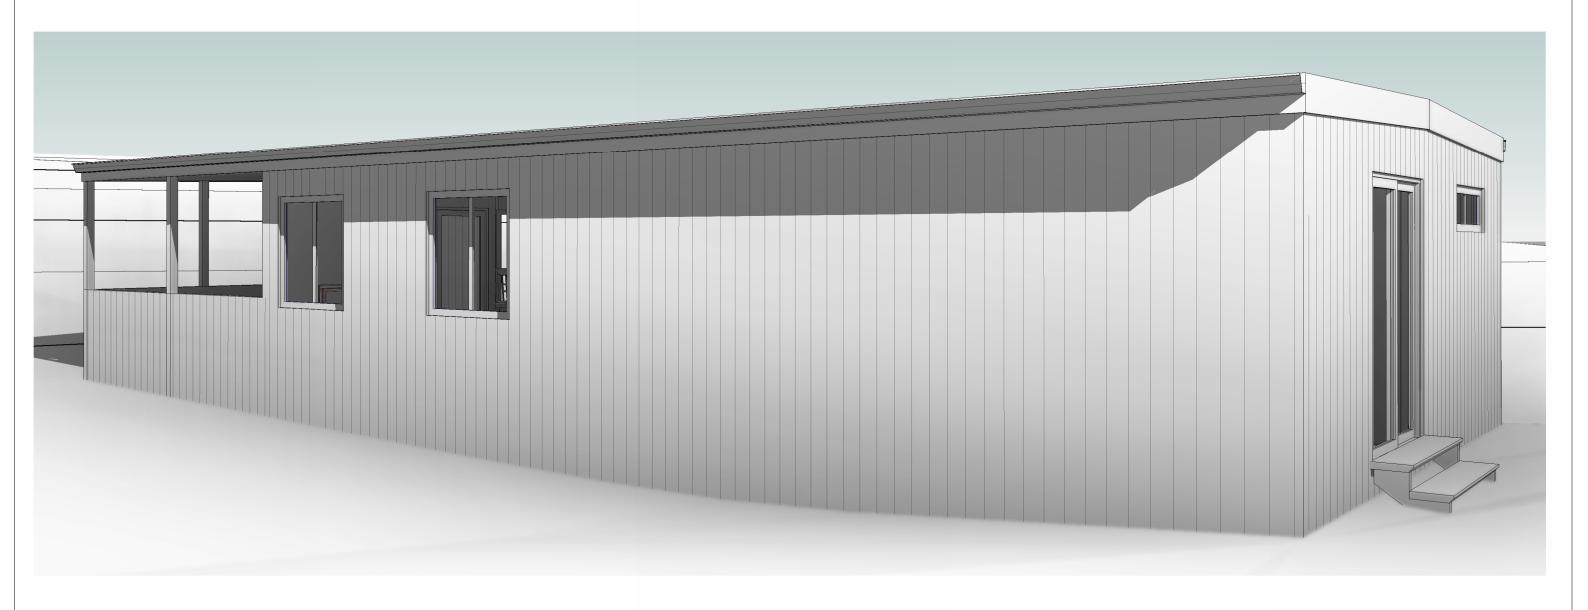
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Client: M. PYKE

Project: AS CONSTRUCTED DWELLING Date Drawn: 06.06.25

Address:31 HILLS ROAD ST HELENS TAS 7216

ENGINEERING

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ST HELENS TAS 7216

Approved: J. Pfeiffer Scale: As Shown @ A3

Office: 6331 7021 info@engineeringplus.com.au

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Checked: J. Pfeiffer

27.10.25 J.C Drawn: J. Chin

11.09.25 J.C

B DEVELOPMENT APPROVAL

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Rev: Amendment:

Drawing No:

20424 A08 / A10

Rev В





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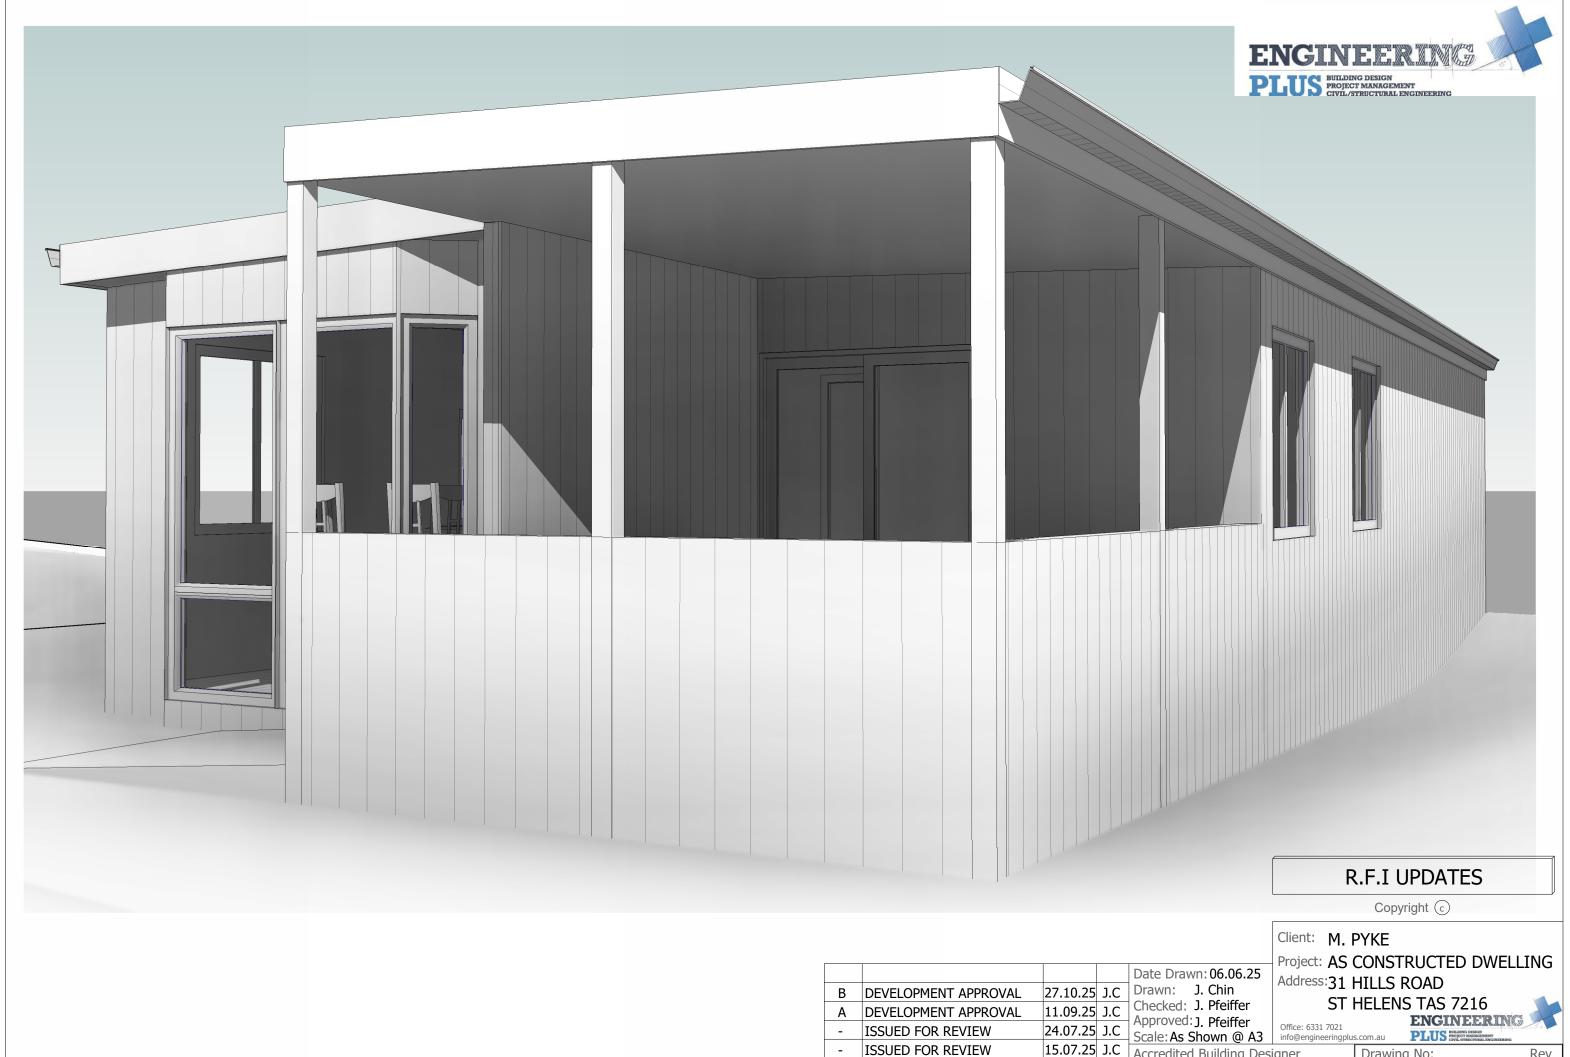
ISSUED FOR REVIEW

Rev: Amendment:

Drawing No:

20424 A09 / A10

Rev



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Rev

15.07.25 J.C Accredited Building Designer Designer Name: J.Pfeiffer Accreditation No: CC2211T

Drawing No:

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