32-34 Georges Bay Esplanade St Helens Tasmania 7216 T: 03 6376 7900 ABN 96 017 131 248



### **Development Applications**

Notice is hereby given under Section 57(3) of the Land Use Planning & Approvals Act 1993 that an application has been made to the Break O' Day Council for a permit for the use or development of land as follows:

**DA Number** DA 2025 / 00173 Plans To Build **Applicant** 

**Proposal** Residential - Partial Demolition of Dwelling & Shed, Alterations/Additions to Dwelling

plus Construction of Shed with Attached Carport

Location 3 Boobyalla Drive, Ansons Bay

Plans and documents can be inspected at the Council Office by appointment, 32 - 34 Georges Bay Esplanade, St Helens during normal office hours or online at www.bodc.tas.gov.au.

Representations must be submitted in writing to the General Manager, Break O'Day Council, 32 -34 Georges Bay Esplanade, St Helens 7216 or emailed to admin@bodc.tas.gov.au, and referenced with the Application Number in accordance with section 57(5) of the abovementioned Act during the fourteen (14) day advertised period commencing on Saturday 1st November, 2025 until 5pm Monday 17th November, 2025.

John Brown GENERAL MANAGER

# at 3 BOOBYALLA DRIVE ANSONS BAY TAS 7264

# for J. R. KERR

PROJECT NUMBER:

25098

PROPERTY ID:

6810282

LAND TITLE, VOLUME & FOLIO

CT - 12275/9

SITE AREA: 1,750m2

FLOOR AREAS:

EXISTING DWELLING FLOOR AREA - 67m<sup>2</sup> EXISTING OUTBUILDING FLOOR AREA - 30m<sup>2</sup> NEW EXTENSION FLOOR AREA - 34m<sup>2</sup> NEW SHED FLOOR AREA - 80m2 NEW CARPORT FLOOR AREA - 48m<sup>2</sup>

COUNCIL: BREAK O' DAY

SCHEME / ZONE:

10.0 LOW DENSITY RESIDENTIAL

SCHEME / ZONE OVERLAYS: **BUSHFIRE PRONE** 

SITE CLASSIFICATION:

WIND CLASSIFICATION: N4

BUSHFIRE ATTACK LEVEL: BALTBD

TERRAIN CLASSIFICATION: TC2.5

WIND REGION: N4


CLIMATE ZONE: 7

CORROSION ENVIRONMENT: MEDIUM

ALPINE AREA: N/A

PRINT DATE:

16/09/2025

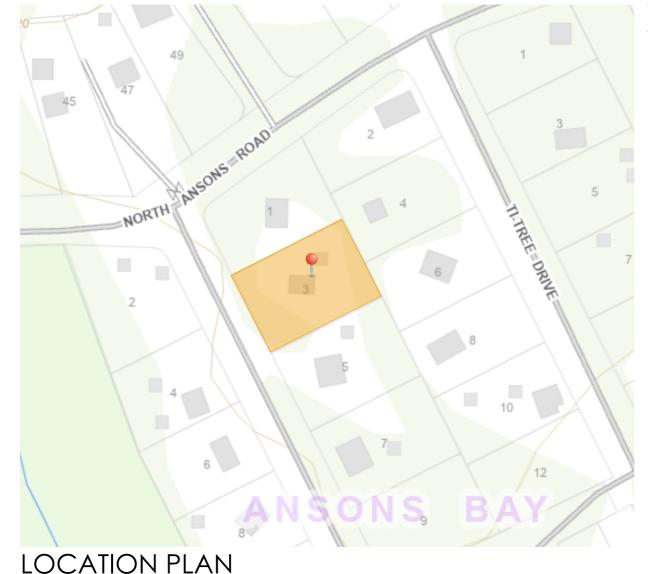

### **DRAWING SCHEDULE**

COVER PAGE

A01 SITE PLAN

A02 SITE DEMOLITION PLAN

DWELLING DEMOLITION FLOOR PLAN

PROPOSED DWELLING FLOOR PLAN

PROPOSED DWELLING ROOF PLAN

**DWELLING NORTHERN & EASTERN ELEVATIONS** 

**DWELLING SOUTHERN & WESTERN ELEVATION** 

PROPOSED DWELLING SECTION AA

PROPOSED SHED FLOOR PLAN

PROPOSED SHED ROOF PLAN

PROPOSED SHED NORTHERN & WESTERN ELEVATION

**REQUIRED APPROVAL STAMPS - BUILDING SURVEYOR / PERMIT AUTHORITY** 

NOTE: THESE DRAWINGS ARE NOT TO BE USED FOR CONSTRUCTION UNLESS THEY ARE STAMPED BY THE BUILDING SURVEYOR AND OR PERMIT AUTHORITY

A12 PROPOSED SHED SOUTHERN ELEVATION





Level 1, Holyman House, 52-60 Brisbane St,

Launceston, Tasmania, 7250.

Tel - 6388 9287 - Mob - 0400 655 771 Email - leigh@planstobuild.com.au

L.M.DELL LIC. No. CC5932 G

#### **GENERAL NOTES:**

IN ACCORDANCE WITH THE N.C.C.S BUILDING CODE OF AUSTRALIA VOLUME TWO. ALL BUILDING WORK SHALL BE IN STRICT COMPLIANCE WITH COUNCIL LAWS REFERENCED AUSTRALIAN STANDARDS, BUILDING ACTS & REGULATIONS REFER ALSO TO THE GENERAL REQUIREMENTS PAGE.

THE BUILDER SHALL SECURE AND MAKE SAFE THE WORKSITE IN ACCORDANCE WITH WORK SAFE TASMANIA & WHS GUIDELINES & REGULATIONS.


THE BUILDER SHALL CARRY OUT DIAL BEFORE YOU DIG REFERRAL FOR LOCATIONS OF ALL UNDERGROUND SERVICES PRIOR TO COMMENCING ANY EARTHWORKS.

THE BUILDER SHALL INSTALL SILT TRAPS & SCREENS AT THE PROPERTY BOUNDARY TO PREVENT SILT RUNOFF INTO THE COUNCIL MAIN SYSTEM FOR THE DURATION OF SITE

THE BUILDER SHALL BE RESPONSIBLE FOR THE CORRECT SETOUT OF ALL WORKS. A LAND SURVEYOR IS RECOMMENDED BY THE DESIGNER FOR ALL SETOUT. USE FIGURED DIMENSIONS IN PREFERENCE TO SCALED DIMENSIONS.


ALL DRAWINGS SHALL BE READ IN CONJUNCTION WITH THE ENGINEERING DRAWINGS AND SPECIFICATIONS. THE DESIGNER SHALL BE NOTIFIED OF ANY DISCREPANCIES WITH THE DRAWINGS.


ALL FITTINGS & FIXTURES INSTALLED SHALL BE PURCHASED AS NEW CONDITION & QUALITY & CARRY THE RELEVANT AUSTRALIAN STANDARD, AND

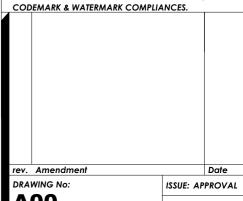



**A00** 

1 of 13 REV: 0

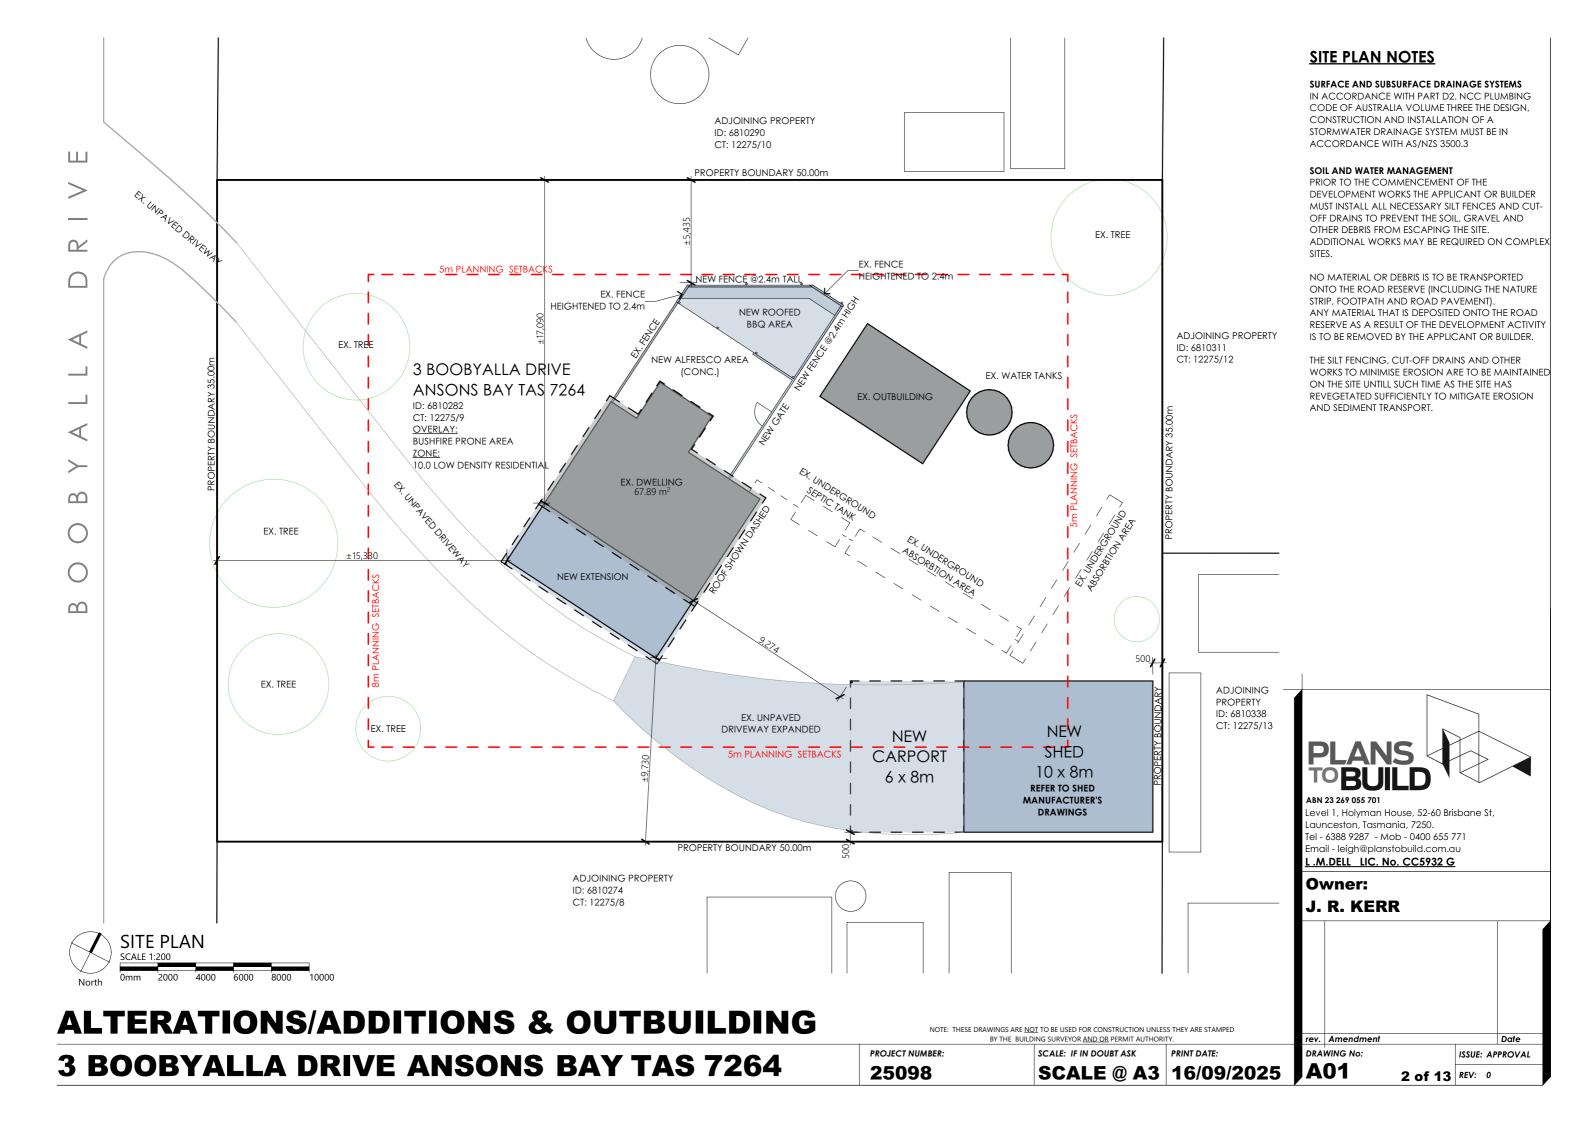

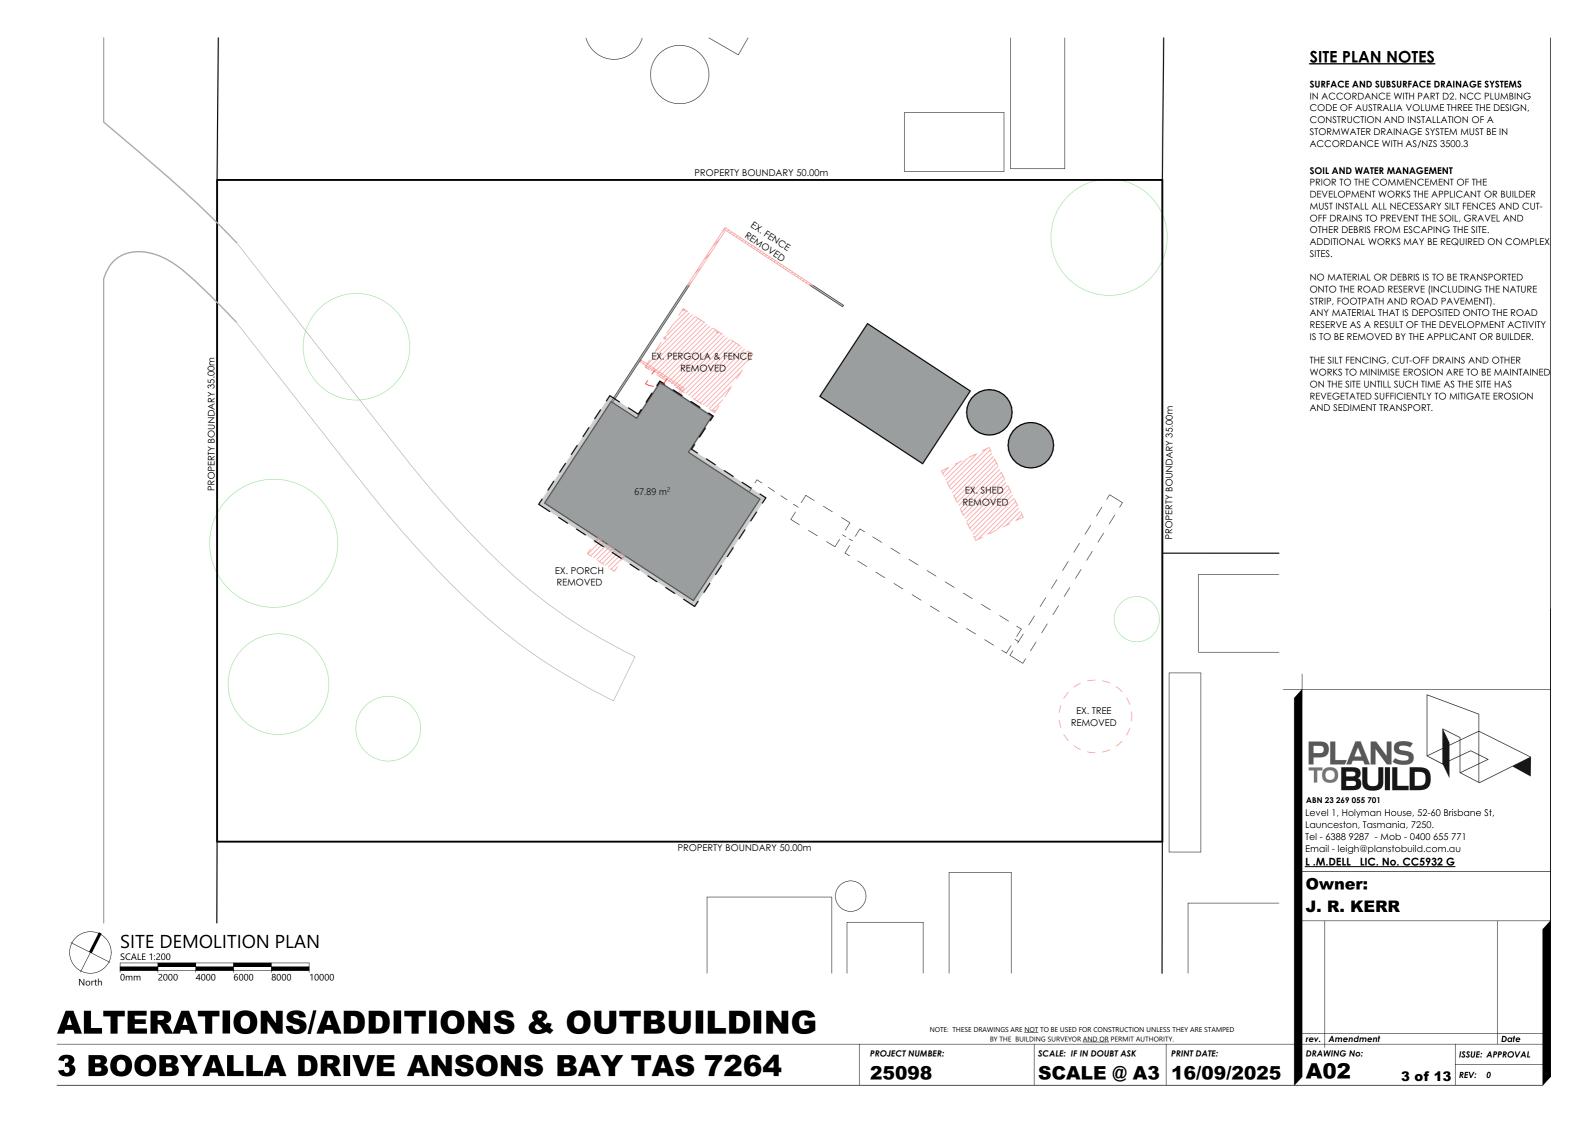

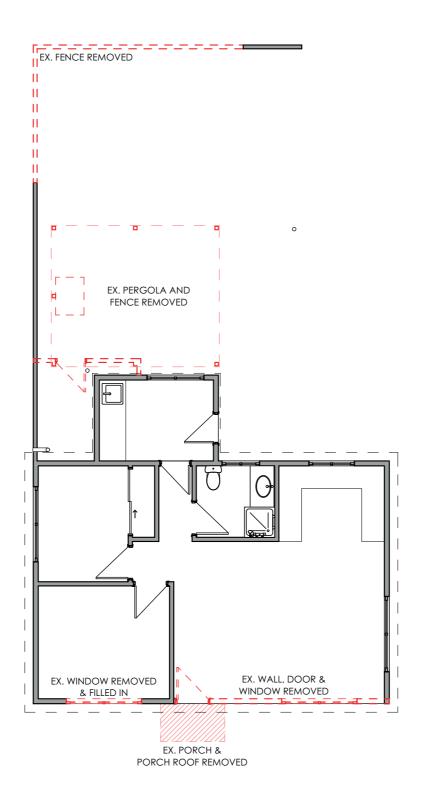

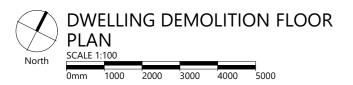

**3 BOOBYALLA DRIVE ANSONS BAY TAS 7264** 

PROJECT NUMBER: 25098


SCALE: IF IN DOUBT ASK

**FLOOR PLAN LEGEND** 





### **DEMOLITON LEGEND**

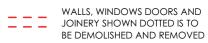




THE CONTRACTOR SHALL CARRY OUT THE REQUIRED DEMOLITON OF THE EXISTING BUILDING ELEMENTS NOMINATED ON THIS PLAN IN STRICT ACCORDANCE WITH THE DOCUMENTATION & AS2601 - THE DEMOLITION OF STRUCTURES.

DEMOLITION WORKS SHALL BE UNDERTAKEN IN A SAFE & ENVIRONMENTALLY ACCEPTABLE MANNER. CONTRACTOR SHALL MAKE ALL ALLOWANCES AS REQUIRED FOR DEMOLITION, REMOVALS & RELOCATIONS TO SUIT THE NEW WORKS.

ALL ITEMS TO BE DEMOLISHED SHOWN DOTTED TYPICALLY. CONTACT DIAL BEFORE YOU DIG PRIOR TO ANY EXCAVATION WORKS. THE EXISTING RESIDENCE MAY CONTAIN ASBESTOS. ANY ASBESTOS SHALL BE REMOVED IN ACCORDANCE WITH WORK SAFE TASMANIA CODE OF PRACTICE CP113 & STATUTORY REGULATIONS

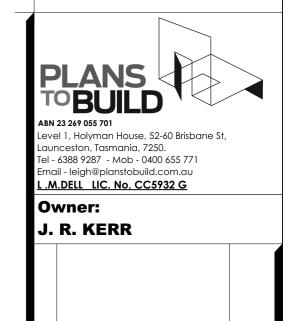


NOTE: THESE DRAWINGS ARE  $\underline{\mathsf{NOT}}$  TO BE USED FOR CONSTRUCTION UNLESS THEY ARE STAMPED BY THE BUILDING SURVEYOR AND OR PERMIT AUTHORITY.

**SCALE @ A3 | 16/09/2025** 

DRAWING No: **A03** 

rev. Amendment

ISSUE: APPROVAL 4 of 13 REV: 0

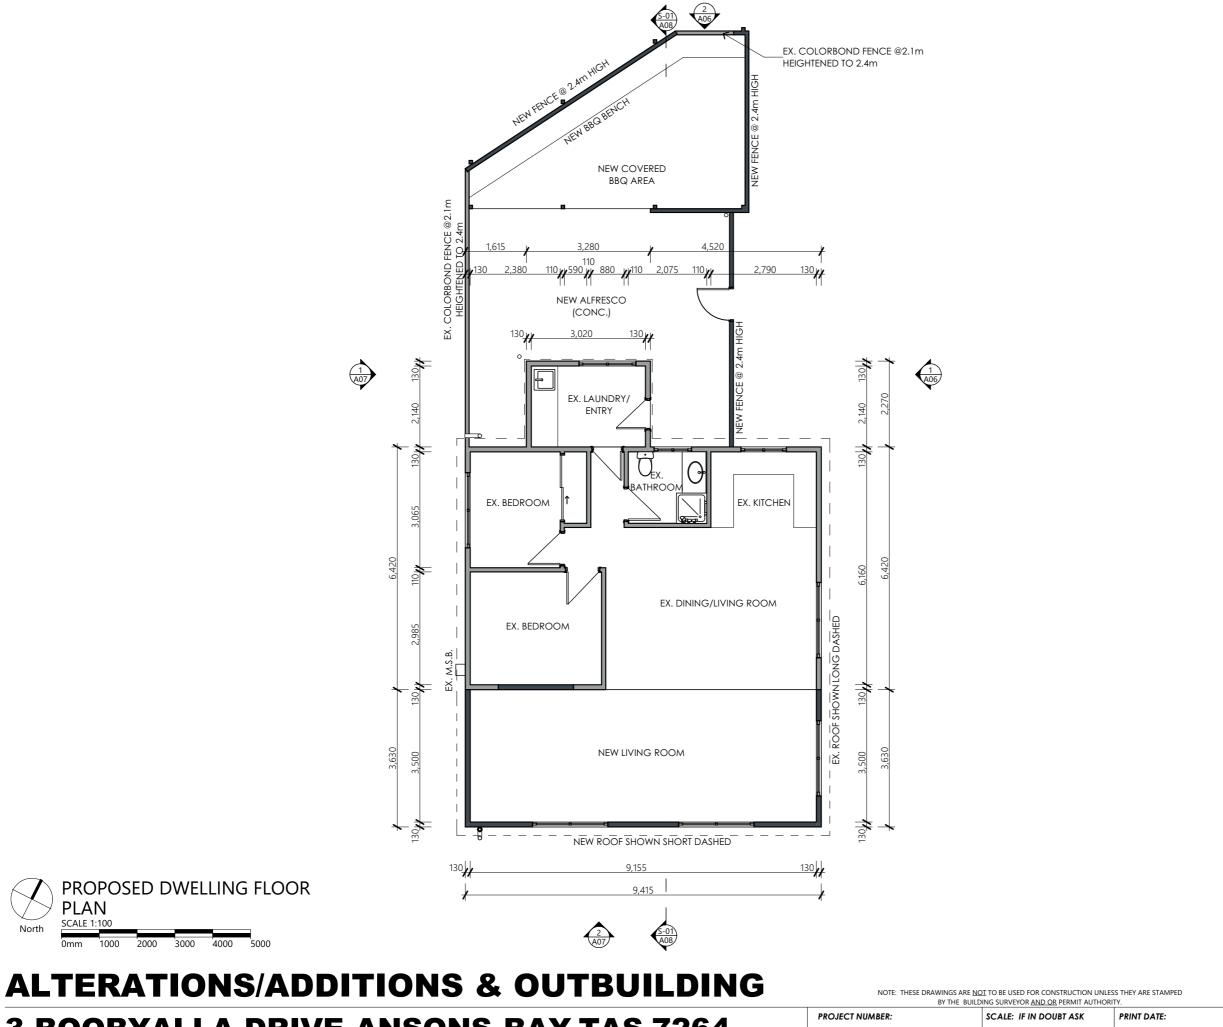

**FLOOR PLAN LEGEND** 

EXISTING WALLS RETAINED

EX. DOORS

NEW WALLS

**NEW DOORS** 

Level 1, Holyman House, 52-60 Brisbane St, Launceston, Tasmania, 7250. Tel - 6388 9287 - Mob - 0400 655 771

Email - leigh@planstobuild.com.au L.M.DELL LIC. No. CC5932 G

Owner:

J. R. KERR

DRAWING No: ISSUE: APPROVAL


25098

SCALE @ A3 | 16/09/2025


**A04** 5 of 13 REV: 0

PROPOSED DWELLING FLOOR

**PLAN** SCALE 1:100

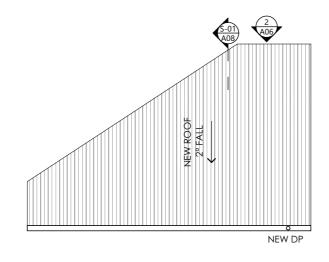



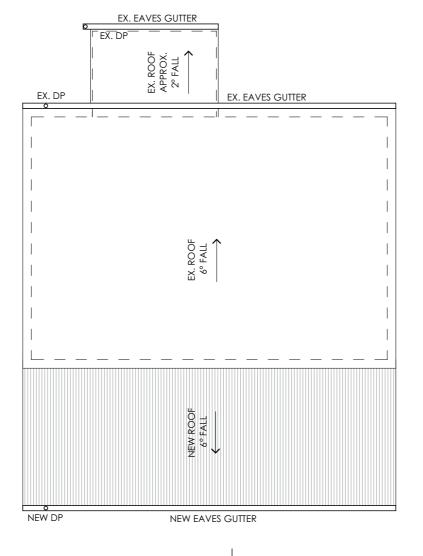







**3 BOOBYALLA DRIVE ANSONS BAY TAS 7264** 

PROJECT NUMBER: 25098

BY THE BUILDING SURVEYOR  $\underline{\mathsf{AND}}\ \mathsf{OR}$  PERMIT AUTHORITY. SCALE: IF IN DOUBT ASK

NOTE: THESE DRAWINGS ARE  $\underline{\mathsf{NOT}}$  to be used for construction unless they are stamped

**SCALE @ A3 | 16/09/2025** 

DRAWING No: **A05** 

rev. Amendment ISSUE: APPROVAL 6 of 13 REV: 0

### **ROOF PLAN NOTES**

METAL SHEET ROOFING SHALL BE IN ACCORDANCE WITH PART 3.5.1. OF THE BCA. WHEREVER POSSIBLE HAVE THE SHEETS LAID SO THAT THE SIDE LAPS ARE FACING AWAY FROM THE PREVAILING WEATHER.

GUTTERS AND DOWNPIPES SHALL BE IN ACCORDANCE WITH PART 3.5.2 OF THE BCA. ALL DWV PVC DOWNPIPES TO BE JOINTED WITH APPROVED SOLVENT AND PRIMER. PAINT FINISH.

AN AUSTRALIAN STANDARD ROOF SAFETY MESH OR AN APPROVED ROOF SAFETY HARNESS OR RESTRAINT SYSTEM SHALL BE USED DURING INSTALLATION.

ROOF SHEETS MUST BE LAID WHEREVER POSSIBLE USING COMPLETE LENGTHS FROM RIDGES TO EAVES. SHEET METAL ROOF, CAPPINGS, FLASHINGS AND PENETRATIONS ARE TO COMPLY WITH PARTS 3.5.1.2 & 3.5.1.3 AND OF THE BCA.

REFER TO ENGINEERS DETAILS FOR ROOF FRAMING. ENSURE THE ROOF SPACE IS VENTILATED AT THE RIDGE CAPPING AND VIA VENTS LOCATED AT THE

ROOF BATTENS MUST BE FIXED IN ACCORDANCE WITH AS 1684.4 SECTION 9 TABLES 9.2 TO 9.7.

REFER TO INSULATION SCHEDULE FOR INSULATION

GUTTERS INSTALLED IN ACCORDANCE WTIH PART 3.5.3 OF THE BCA, NCC. 1 IN 500 FALL.

BOX GUTTERS WITH 1 IN 100 FALL AND IN ACCORDANCE WITH AS/NZS 3500.3





Level 1, Holyman House, 52-60 Brisbane St, Launceston, Tasmania, 7250. Tel - 6388 9287 - Mob - 0400 655 771

Email - leigh@planstobuild.com.au L.M.DELL LIC. No. CC5932 G

### Owner:

J. R. KERR

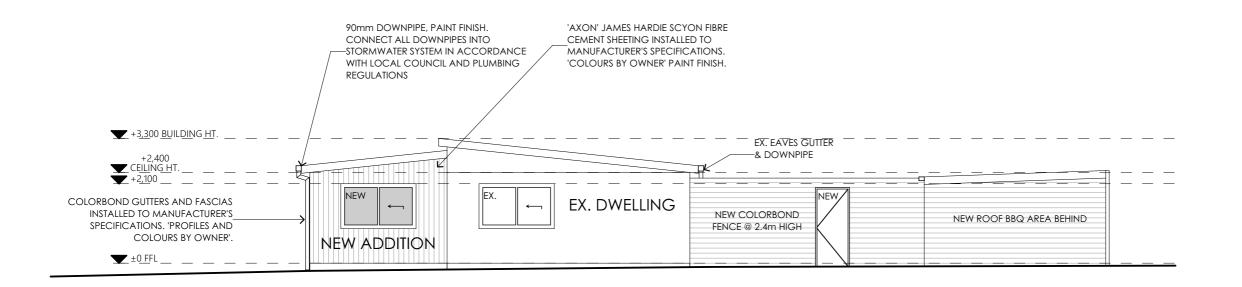

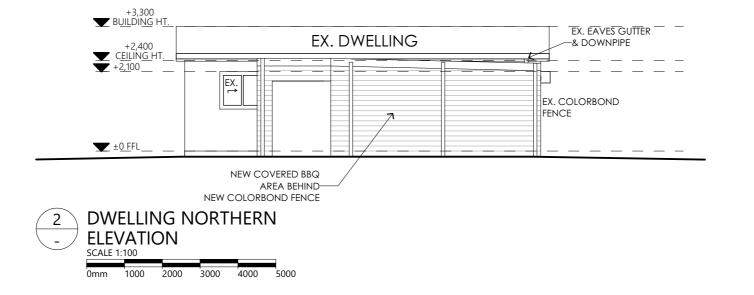

# ALTERATIONS/ADDITIONS & OUTBUILDING 3 BOOBYALLA DRIVE ANSONS BAY TAS 7264

**DWELLING EASTERN ELEVATION** 

2000

3000 4000

PROJECT NUMBER: **25098** 

BY THE BUILDING SURVEYOR AND OR PERMIT AUTHORITY.

SCALE: IF IN DOUBT ASK

P

COAL E @ A 2

NOTE: THESE DRAWINGS ARE  $\underline{\mathsf{NOT}}$  to be used for construction unless they are stamped


SCALE @ A3 16/09/2025


INSTALL THE WALL CLADDING SYSTEM COMPLETE WITH JOINTS, TRIMS, FLASHINGS , SEALS , FIXINGS


WALL CLADDING SYSTEMS MUST BE INSTALLED IN STRICT ACCORDANCE WITH MANUFACTURES DETAILS, INSTRUCTIONS & SPECIFICATIONS.


**ELEVATION NOTES** 

& FINISHES IN STRICT ACCORDANCE WITH MANUFACTURES DETAILS TO ENSURE A WEATHER-PROOF AND WATERTIGHT INSTALLATION.

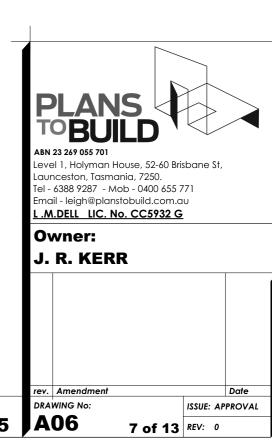

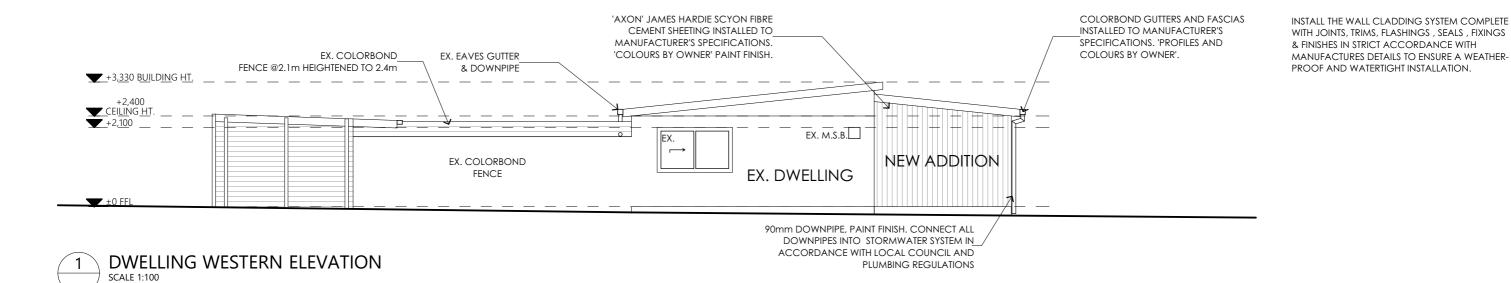

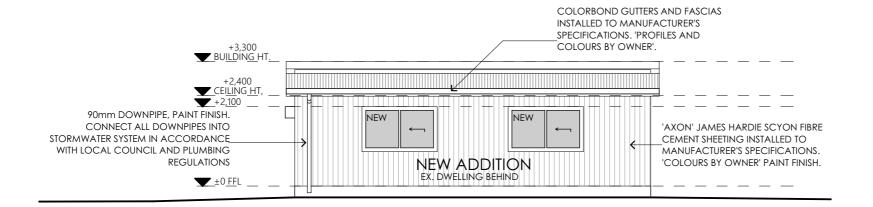

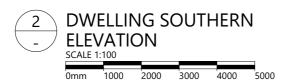

**3 BOOBYALLA DRIVE ANSONS BAY TAS 7264** 

NOTE: THESE DRAWINGS ARE <u>NOT</u> TO BE USED FOR CONSTRUCTION UNLESS THEY ARE STAMPED BY THE BUILDING SURVEYOR <u>AND OR</u> PERMIT AUTHORITY.

PROJECT NUMBER: SCALE: IF IN DOUBT ASK

25098

SCALE @ A

SCALE @ A3 16/09/2025

rev. Amendment
DRAWING No:
A6/09/2025

ABN 23 269 055 701
Level 1, Holyman House, 52-60 Brisbane St,
Launceston, Tasmania, 7250.
Tel - 6388 9287 - Mob - 0400 655 771
Email - leigh@planstobuild.com.au
L.M.DELL LIC. No. CC5932 G


Owner:
J. R. KERR


ISSUE: APPROVAL

8 of 13 REV: 0

**ELEVATION NOTES** 

WALL CLADDING SYSTEMS MUST BE INSTALLED IN STRICT ACCORDANCE WITH MANUFACTURES DETAILS, INSTRUCTIONS & SPECIFICATIONS.

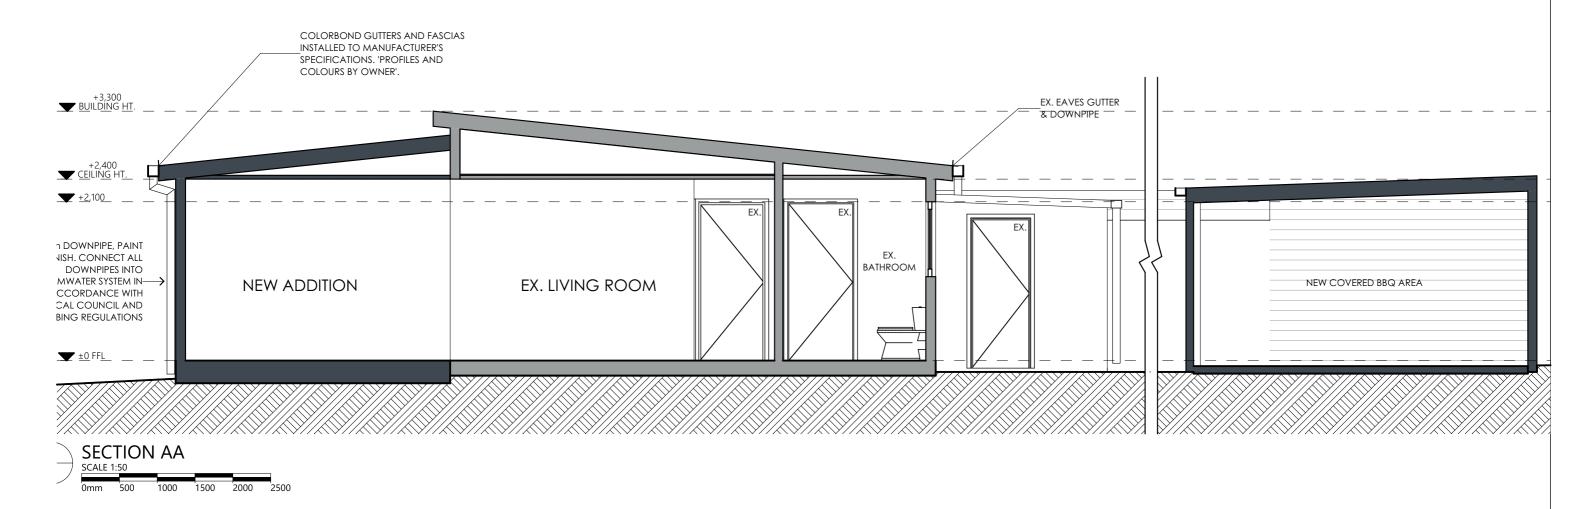

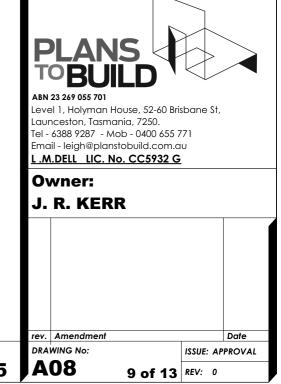



PROJECT NUMBER: 25098

SCALE: IF IN DOUBT ASK

NOTE: THESE DRAWINGS ARE  $\underline{\mathsf{NOT}}$  TO BE USED FOR CONSTRUCTION UNLESS THEY ARE STAMPED BY THE BUILDING SURVEYOR AND OR PERMIT AUTHORITY.

> PRINT DATE: SCALE @ A3 | 16/09/2025

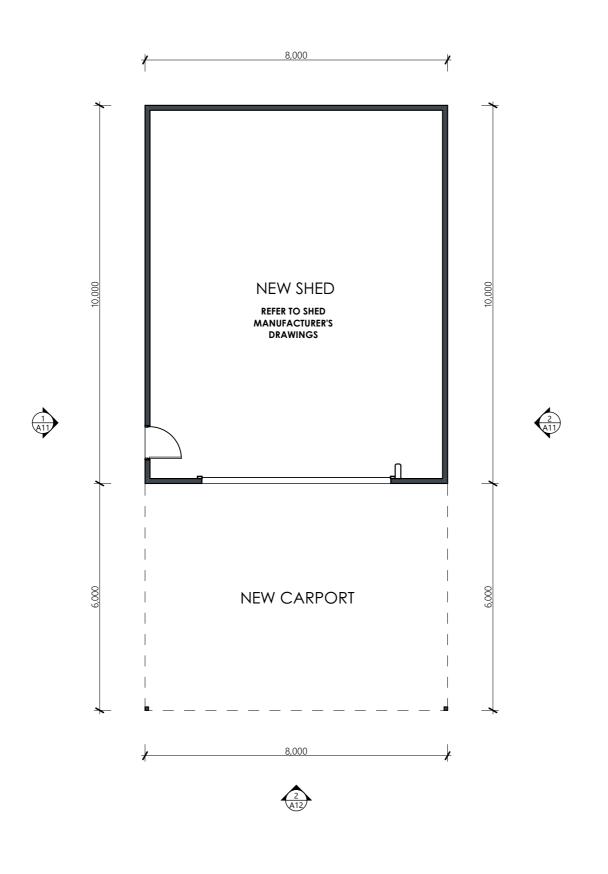

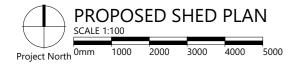

**3 BOOBYALLA DRIVE ANSONS BAY TAS 7264** 

PROJECT NUMBER: 25098

SCALE @ A3 | 16/09/2025

Level 1, Holyman House, 52-60 Brisbane St, Launceston, Tasmania, 7250. Tel - 6388 9287 - Mob - 0400 655 771 Email - leigh@planstobuild.com.au L.M.DELL LIC. No. CC5932 G Owner: J. R. KERR DRAWING No: ISSUE: APPROVAL **A09** 10 of 13 REV: 0

**FLOOR PLAN LEGEND** 


EX. DOORS

NEW WALLS

**NEW DOORS** 

EXISTING WALLS RETAINED

NOTE: THESE DRAWINGS ARE  $\underline{\mathsf{NOT}}$  TO BE USED FOR CONSTRUCTION UNLESS THEY ARE STAMPED BY THE BUILDING SURVEYOR AND OR PERMIT AUTHORITY. SCALE: IF IN DOUBT ASK PRINT DATE:

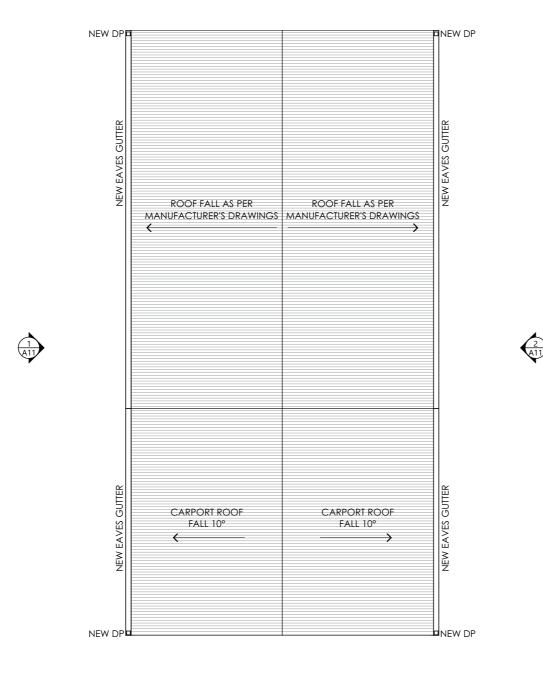





**3 BOOBYALLA DRIVE ANSONS BAY TAS 7264** 

PROJECT NUMBER: 25098

BY THE BUILDING SURVEYOR AND OR PERMIT AUTHORITY. SCALE: IF IN DOUBT ASK

NOTE: THESE DRAWINGS ARE  $\underline{\mathsf{NOT}}$  TO BE USED FOR CONSTRUCTION UNLESS THEY ARE STAMPED

**SCALE @ A3 | 16/09/2025** 

rev. Amendment DRAWING No: A10

ISSUE: APPROVAL 11 of 13 REV: 0

WITH PART 3.5.1. OF THE BCA. WHEREVER POSSIBLE HAVE THE SHEETS LAID SO THAT THE SIDE LAPS ARE FACING AWAY FROM THE PREVAILING WEATHER. GUTTERS AND DOWNPIPES SHALL BE IN ACCORDANCE WITH PART 3.5.2 OF THE BCA.

ALL DWV PVC DOWNPIPES TO BE JOINTED WITH APPROVED SOLVENT AND PRIMER. PAINT FINISH.

METAL SHEET ROOFING SHALL BE IN ACCORDANCE

**ROOF PLAN NOTES** 

AN AUSTRALIAN STANDARD ROOF SAFETY MESH OR AN APPROVED ROOF SAFETY HARNESS OR RESTRAINT SYSTEM SHALL BE USED DURING INSTALLATION.

ROOF SHEETS MUST BE LAID WHEREVER POSSIBLE USING COMPLETE LENGTHS FROM RIDGES TO EAVES. SHEET METAL ROOF, CAPPINGS, FLASHINGS AND PENETRATIONS ARE TO COMPLY WITH PARTS 3.5.1.2 & 3.5.1.3 AND OF THE BCA.

REFER TO ENGINEERS DETAILS FOR ROOF FRAMING. ENSURE THE ROOF SPACE IS VENTILATED AT THE RIDGE CAPPING AND VIA VENTS LOCATED AT THE

ROOF BATTENS MUST BE FIXED IN ACCORDANCE WITH AS 1684.4 SECTION 9 TABLES 9.2 TO 9.7.

REFER TO INSULATION SCHEDULE FOR INSULATION

GUTTERS INSTALLED IN ACCORDANCE WTIH PART 3.5.3 OF THE BCA, NCC. 1 IN 500 FALL.

BOX GUTTERS WITH 1 IN 100 FALL AND IN ACCORDANCE WITH AS/NZS 3500.3




Level 1, Holyman House, 52-60 Brisbane St, Launceston, Tasmania, 7250. Tel - 6388 9287 - Mob - 0400 655 771


Email - leigh@planstobuild.com.au L.M.DELL LIC. No. CC5932 G

### Owner:

J. R. KERR

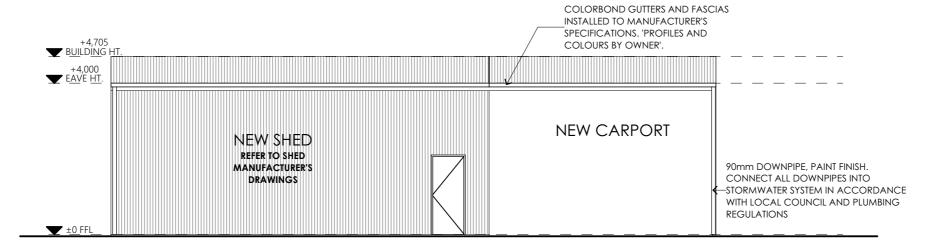



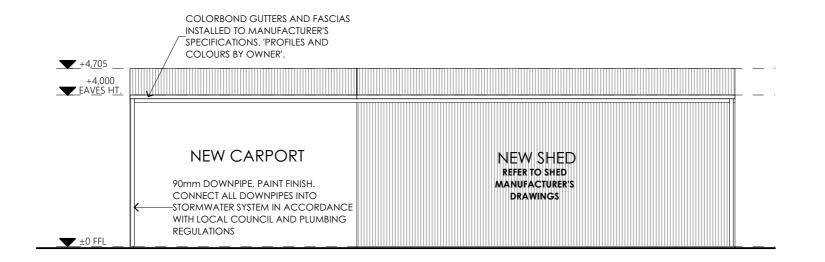



**3 BOOBYALLA DRIVE ANSONS BAY TAS 7264** 

NOTE: THESE DRAWINGS ARE  $\underline{\mathsf{NOT}}$  to be used for construction unless they are stamped BY THE BUILDING SURVEYOR AND OR PERMIT AUTHORITY.

PROJECT NUMBER: 25098

SCALE: IF IN DOUBT ASK

SCALE @ A3 | 16/09/2025 JA11


12 of 13 REV: 0


### **ELEVATION NOTES**

WALL CLADDING SYSTEMS MUST BE INSTALLED IN STRICT ACCORDANCE WITH MANUFACTURES DETAILS, INSTRUCTIONS & SPECIFICATIONS.

INSTALL THE WALL CLADDING SYSTEM COMPLETE WITH JOINTS, TRIMS, FLASHINGS, SEALS, FIXINGS & FINISHES IN STRICT ACCORDANCE WITH MANUFACTURES DETAILS TO ENSURE A WEATHER-PROOF AND WATERTIGHT INSTALLATION.

PLANS TOBUILD  ABN 23 269 055 701  Level 1, Holyman House, 52-60 Brisbane St, Launceston, Tasmania, 7250.  Tel - 6388 9287 - Mob - 0400 655 771  Email - leigh@planstobuild.com.au  L.M.DELL LIC. No. CC5932 G  Owner:			
J.	Amendment		Date
DRAWING No:		ISSUE: APPROVAL	

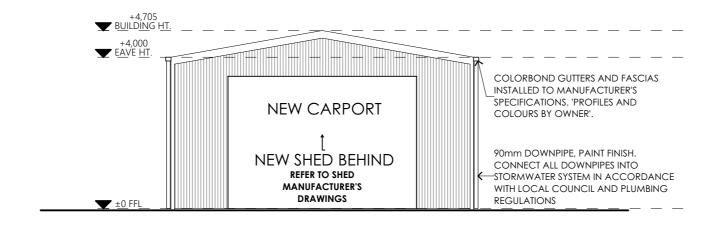


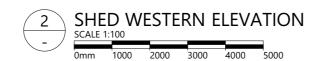

### **ELEVATION NOTES**

WALL CLADDING SYSTEMS MUST BE INSTALLED IN STRICT ACCORDANCE WITH MANUFACTURES DETAILS, INSTRUCTIONS & SPECIFICATIONS.

INSTALL THE WALL CLADDING SYSTEM COMPLETE WITH JOINTS, TRIMS, FLASHINGS, SEALS, FIXINGS & FINISHES IN STRICT ACCORDANCE WITH MANUFACTURES DETAILS TO ENSURE A WEATHER-PROOF AND WATERTIGHT INSTALLATION.

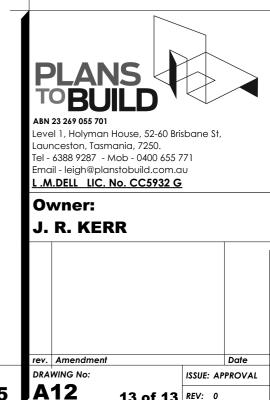

# **ALTERATIONS/ADDITIONS & OUTBUILDING**

**3 BOOBYALLA DRIVE ANSONS BAY TAS 7264** 

PROJECT NUMBER: 25098

BY THE BUILDING SURVEYOR AND OR PERMIT AUTHORITY. SCALE: IF IN DOUBT ASK

NOTE: THESE DRAWINGS ARE  $\underline{\mathsf{NOT}}$  TO BE USED FOR CONSTRUCTION UNLESS THEY ARE STAMPED

PRINT DATE:

SCALE @ A3 | 16/09/2025

13 of 13 REV: 0



#### **DEVELOPMENT APPLICATION - FIR RESPONSE**

### **Project**

Alterations, Additions & Outbuilding – 3 Boobyalla Dr, Ansons Bay Tas, 7264

#### The site

The site, a Torrens Title volume CT- 12275 Folio 9 and is located within the Low-Density zone of the Tasmanian - Launceston planning scheme, the scheme.

#### FIR Response

2.

The proposed new carport and new shed are to be located within 5m of both the side and rear boundary. The proposal will rely therefore on performance criteria. Please provide a written submission demonstrating how the proposed carport and shed will meet P2 of clause 10.4.3 Setback (Planning Scheme Viewer).

### FIR P2 Response

The siting of a dwelling must not cause an unreasonable loss of amenity to adjoining properties, having regard to:

### (a) the topography of the site;

The Topography (cleared grassy and flat) enables the proposed shed & carport to be constructed with-out any major earthworks, while still maintaining full amenity to the existing dwelling

#### (b) the size, shape and orientation of the site;

The size, shape and orientation of the site enable the proposed shed & carport to be constructed while still maintaining full amenity to the existing dwelling. The Lot site of 1.750m2 is large enough to accommodate the proposed new outbuilding and provide for adequate access.

#### (c) the setbacks of surrounding buildings;

The Setback of the Proposed new shed & carport is consistent with other similar sheds on adjoining properties that are located at or near the Boundary. It is deemed that no loss of amenity to adjoining properties will occur from the proposed new shed & carport.

### (d) the height, bulk and form of existing and proposed buildings;

The size of the Proposed new shed & Carport is consistent with other similar sheds on adjoining properties that provide for the storage of vehicle and boats.



Level 1, 52-60 Brisbane Street , Launceston Tas 7250.
Tel - 633 89914 - Mob -0400 655 771 - Email leigh@planstobuild.com.au



### (e) the existing buildings and private open space areas on the site;

The Proposed shed & carport allows to maintain the existing Private open space directly associated with the existing dwelling

(f) sunlight to private open space and windows of habitable rooms on adjoining properties;

The proposed new shed & carport can be constructed while still maintaining full solar amenity to the existing dwelling

(g) the character of development existing on established properties in the area.

The proposed new shed is considered to be in Character with the existing surrounding proposed, many of which are of metal colorbond construction.

The modest dwelling extensions are deemed to meet the requirements of the scheme.

3.

The existing unpaved driveway is to be expanded as part of the proposed works. The proposal will rely therefore on performance criteria. Please provide a written submission demonstrating how the proposed driveway extension will meet P1 of clause C2.6.1 Construction of parking areas (Planning Scheme Viewer) and ensure that the surface material is clearly identified.

#### FIR P1 Response

All parking, access ways, manoeuvring and circulation spaces must be readily identifiable and constructed so that they are useable in all weather conditions, having regard to:

#### (a) the nature of the use;

The existing lot is grassed with a sand / fine gravel driveway, all weather Gravel road and access.

### (b) the topography of the land;

The Topography (cleared grassy and flat) with easy level access and now change in gradients

#### (c) the drainage system available;

The existing lot is serviced by a stormwater drain that discharges to an open council swale drain to collect run-off.

(d) the likelihood of transporting sediment or debris from the site onto a road or public place; The existing lot is grassed with a sand / fine gravel driveway, all weather Gravel road and access. Grassed areas will trap any sediment.

#### (e) the likelihood of generating dust.

See as above (d)



Level 1, 52-60 Brisbane Street , Launceston Tas 7250.
Tel - 633 89914 - Mob -0400 655 771 - Email leigh@planstobuild.com.au



### (f) the nature of the proposed surfacing.

See as above (d)

Yours Faithfully

L.M. DELL

17.10.25

