32-34 Georges Bay Esplanade St Helens Tasmania 7216 T: 03 6376 7900 ABN 96 017 131 248



Development Applications

Notice is hereby given under Section 57(3) of the Land Use Planning & Approvals Act 1993 that an application has been made to the Break O' Day Council for a permit for the use or development of land as follows:

DA Number DA 2024 / 00055 Applicant **Engineering Plus**

Proposal Residential - Construction of Deck & Roof

Location 259 Medeas Cove Road, St Helens (CT 181557/3)

Plans and documents can be inspected at the Council Office by appointment, 32 - 34 Georges Bay Esplanade, St Helens during normal office hours or online at www.bodc.tas.gov.au.

Representations must be submitted in writing to the General Manager, Break O'Day Council, 32 -34 Georges Bay Esplanade, St Helens 7216 or emailed to admin@bodc.tas.gov.au, and referenced with the Application Number in accordance with section 57(5) of the abovementioned Act during the fourteen (14) day advertised period commencing on Saturday 13 April 2024 until 5pm Monday 29 April 2024.

John Brown **GENERAL MANAGER**



DRAWING SCHEDULE

A00 COVER PAGE
A01 LOCALITY PLAN
A02 SITE PLAN

A03 CONSTRUCTION PLAN

A04 ELEVATIONS
A05 ROOF PLAN
A06 3D PERSPECTIVES

ISSUED FOR APPROVAL

PROPOSED DECK & ROOF

K. BENNY 259a MEDEAS COVE ROAD ST HELENS

BREAK O'DAY COUNCIL

PROJECT INFORMATION

BUILDING DESIGNER: GRANT JAMES PFEIFFER

ACCREDITATION No: CC2211T
BUILDING CLASS: CLASS 10
LAND TITLE REFERENCE NUMBER: 181557/3
DESIGN WIND SPEED: N2

SOIL CLASSIFICATION: 'M'
CLIMATE ZONE: 7
BUSHFIRE-PRONE BAL RATING: 12.5
AI PINF ARFA: N/A

CORROSION ENVIRONMENT: MODERATE

FLOODING: NO LANDSLIP: NO

DISPERSIVE SOILS:

SALINE SOILS:

UNKNOWN
UNKNOWN
SAND DUNES:

NO


MINE SUBSIDENCE: NO LANDFILL: NO


GROUND LEVELS: REFER PLAN

ORG LEVEL: 75MM ABOVE GROUND LEVEL SURFACE

DEVELOPMENT AREA				
Name	Area			
EXISTING DWELLING	124.45 m ²			
PROPOSED DECK	47.55 m²			
FRONT LANDING	5.16 m ²			
BACK LANDING	2.16 m ²			
LAUNDRY LANDING	2.16 m ²			

181.48 m²

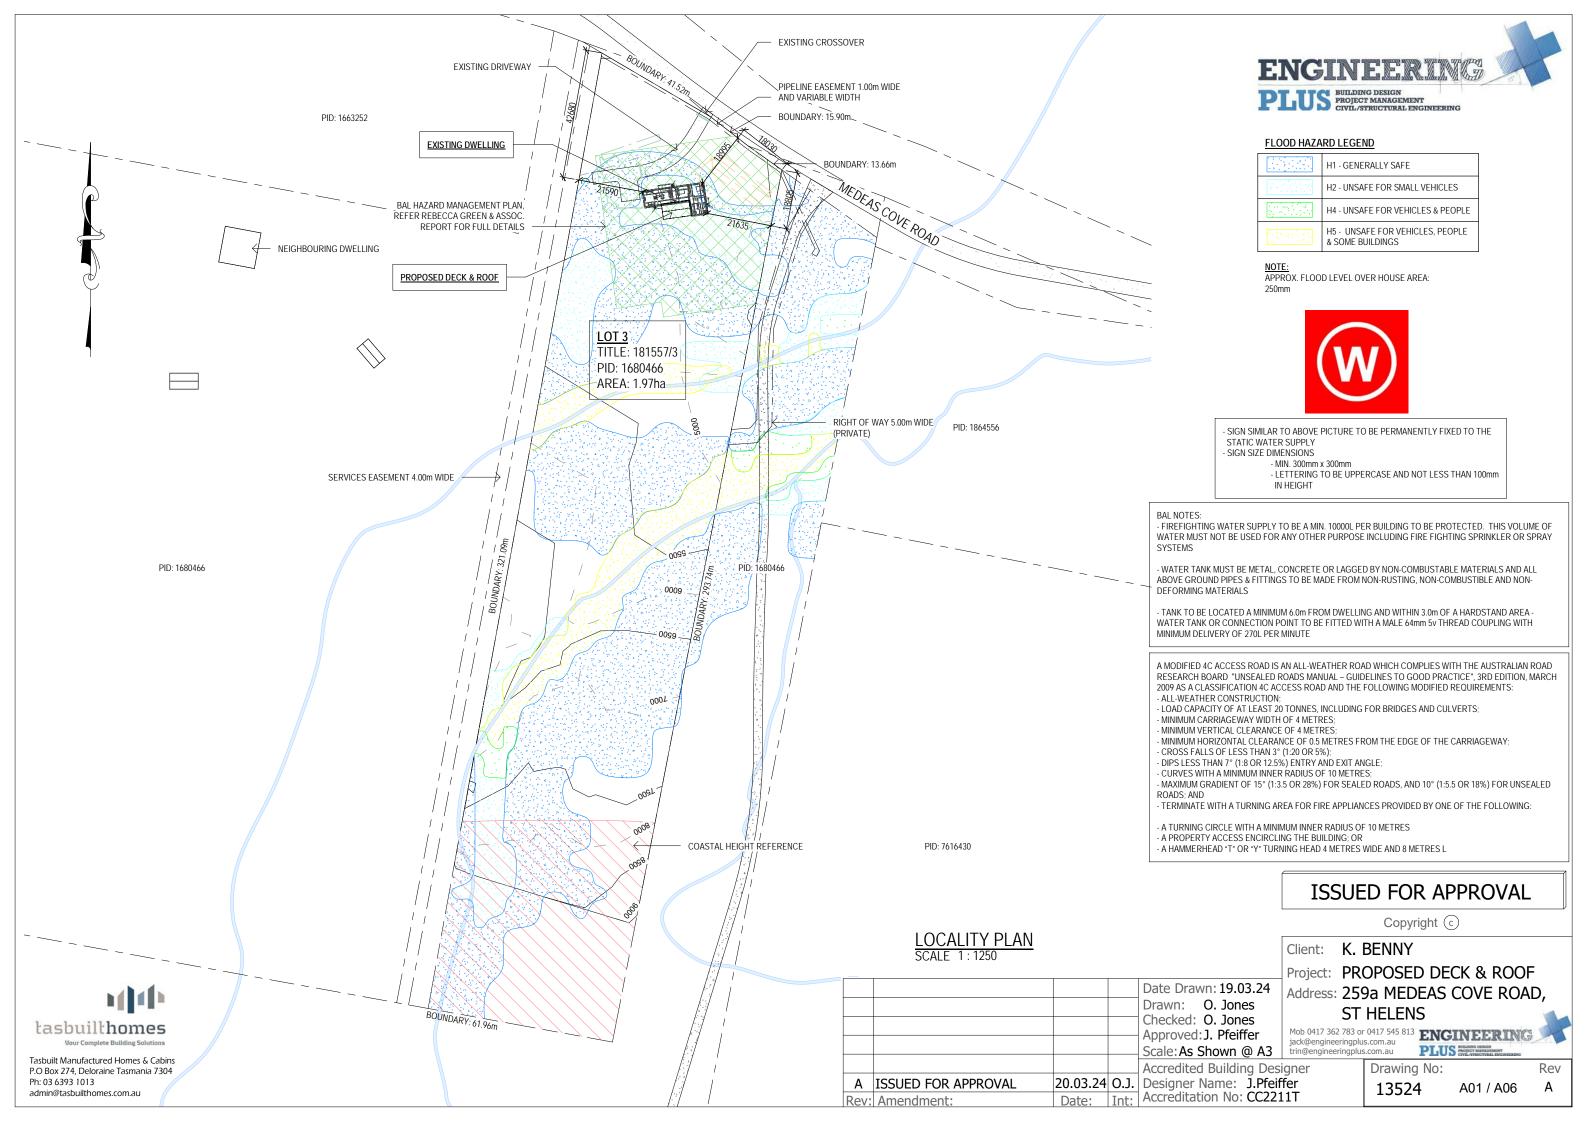

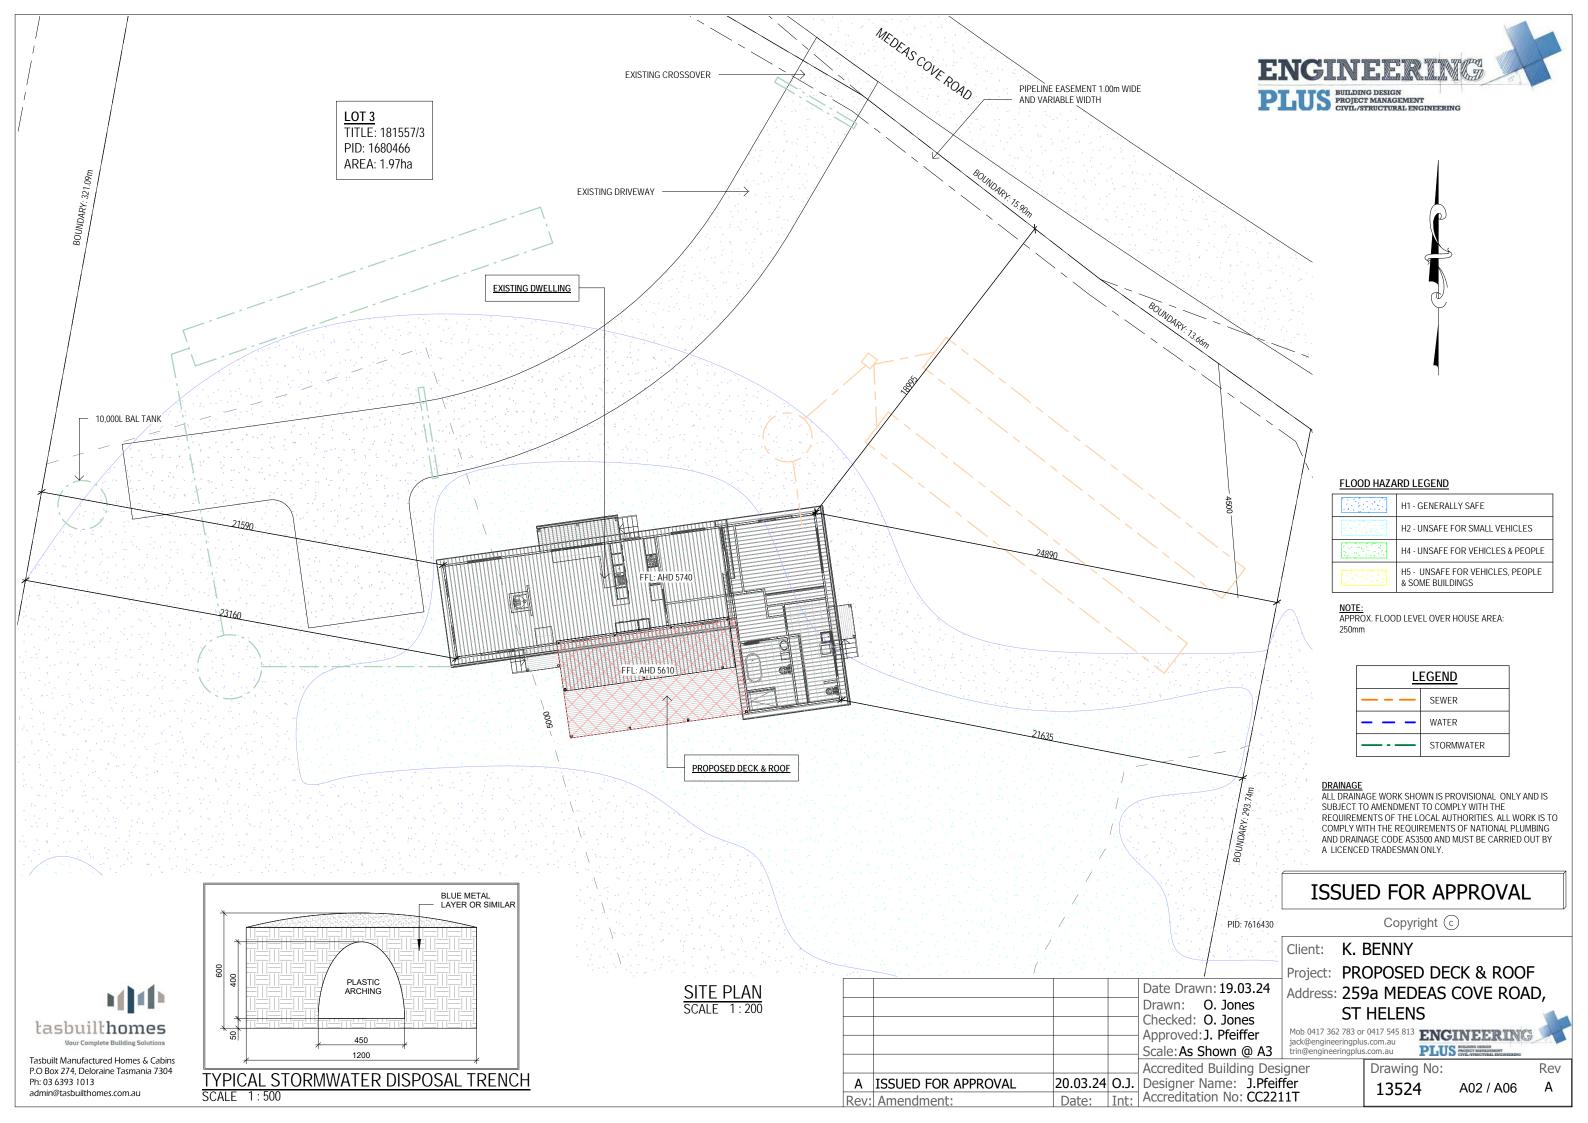







CONSTRUCTION PLAN SCALE 1:100

Area Schedule (Gross Building)

Area (sq) Name Area EXISTING DWELLING 124.45 m² 13.40 FRONT LANDING 5.16 m² 0.56 BACK LANDING 2.16 m² 0.23 LAUNDRY LANDING 2.16 m² 0.23 PROPOSED DECK 47.55 m² 5.12 181.48 m² 19.53

					PIU
				Date Drawn: 19.03.24	Add
				Drawn: O. Jones	,
				Checked: O. Jones	NA-I-
				Approved: J. Pfeiffer	Mob jack@
				Scale: As Shown @ A3	trin@
				Accredited Building Designe	
Α	ISSUED FOR APPROVAL	20.03.24	O.J.	Designer Name: J.Pfeif	fer
Rev:	Amendment:	Date:	Int:	Accreditation No: CC221	L1T

ISSUED FOR APPROVAL

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Client: K. BENNY

Project: PROPOSED DECK & ROOF

Address: 259a MEDEAS COVE ROAD,

ST HELENS

Mob 0417 362 783 or 0417 545 813 jack@engineeringplus.com.au trin@engineeringplus.com.au

Drawing No:

13524 A03 / A06 Rev

Tasbuilt Manufactured Homes & Cabins P.O Box 274, Deloraine Tasmania 7304 admin@tasbuilthomes.com.au

tasbuilthomes

Ph: 03 6393 1013


SUB FLOOR VENTILATION. BCA VOLUME 2 PART 3.4.1.

- A MINIMUM OF 150 MM OF SUB FLOOR CLEARANCE IS TO BE PROVIDED BETWEEN FINISHED SURFACE LEVEL & THE UNDERSIDE OF THE FLOOR BEARER.
- A MINIMUM of 6000 MM2 PER METRE OF SUB FLOOR VENTILATION IS TO BE UNIFORMLY DISTRIBUTED AROUND THE EXTERNAL AND INTERNAL WALLS OF THE BUILDING.
- VENTS TO BE LOCATED NO GREATER THAN 600 MM FROM AN INTERNAL OR EXTERNAL CORNER.


PRYDA 230x75 - 52 HOLE VENT MAXIMUM SPACING 1050 MM ALONG WALL OR PRYDA 230x165 - 117 HOLE VENT MAXIMUM SPACING 2350 MM ALONG WALL

ADDITIONAL VENTILATION PROVISIONS TO BE INSTALLED WHERE OBSTRUCTIONS SUCH AS CONCRETE VERANDAH'S, DECKS, PATIOS AND PAVING ARE INSTALLED & OBSTRUCT VENTILATION.



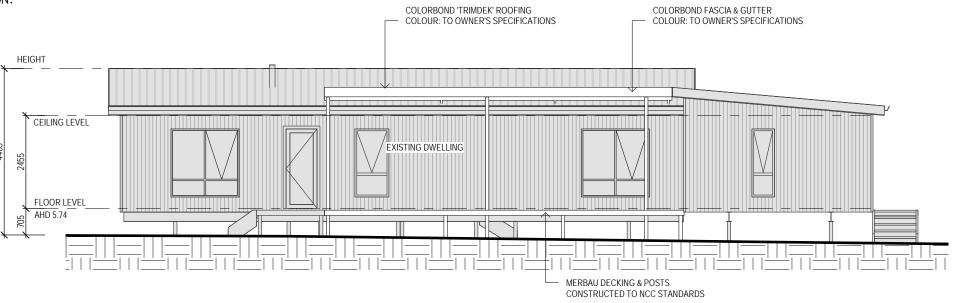

SOUTH ELEVATION SCALE 1:100

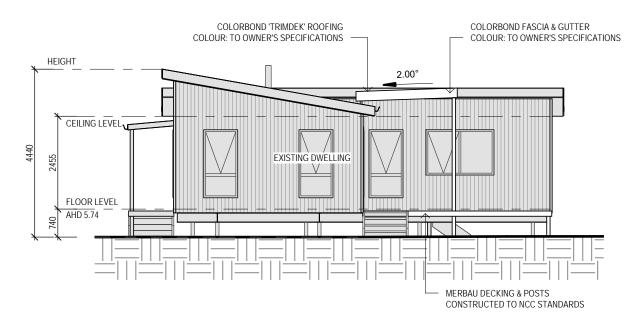

WEST ELEVATION SCALE 1:100

STAIR CONSTRUCTION. BCA Volume 2 Part 3.9

• TREADS: 240 MM

• RISERS: 180 MM

20.03.24 O.J. Designer Name: J.Pfeiffer

Date: Int: Accreditation No: CC2211T

- TREATED PINE TIMBER STAIR MATERIAL TO ASI684
- TREATMENT LEVELS H4 FOR INGROUND USE & H3 FOR ABOVE GROUND USE.
- ALL FIXINGS FITTING BRACKETS AND CONNECTORS TO BE GALVANISED.
- STRINGER: 300x50 F5 TREATED PINE
- TREADS: 240x45 F5 TREATED PINE MAXIMUM TREAD SPAN 1000

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Client: K. BENNY

Project: PROPOSED DECK & ROOF

Address: 259a MEDEAS COVE ROAD,

ST HELENS

jack@engineeringplus.com.au trin@engineeringplus.com.au

Mob 0417 362 783 or 0417 545 813 **ENGINEERING**

PLUS PROJECT MANAGEMENT

Rev

Α

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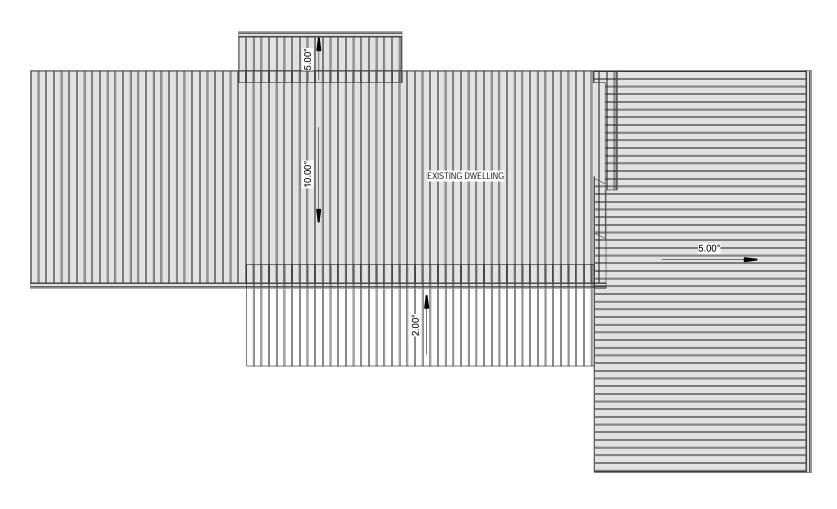
tasbuilthomes Tasbuilt Manufactured Homes & Cabins P.O Box 274, Deloraine Tasmania 7304 Ph: 03 6393 1013 admin@tasbuilthomes.com.au

Date Drawn: 19.03.24 Drawn: O. Jones Checked: O. Jones Approved: J. Pfeiffer Scale: As Shown @ A3 Accredited Building Designer

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ROOF PLAN

ROOF CLADDING. BCA VOLUME 2 PART 3.5.1.3

COLORBOND 'CUSTOM ORB' METAL SHEETING INSTALLED IN ACCORDANCE WITH THIS PART, AS 1562.1 AND MANUFACTURERS RECOMMENDATIONS.

COLORBOND 'TRIMDEK' METAL SHEETING INSTALLED IN ACCORDANCE WITH THIS PART, AS 1562.1 AND MANUFACTURERS RECOMMENDATIONS.

REFER TO LYSAGHT ROOFING & WALLING MANUAL FOR FULL DETAILS ON SHEET INSTALLATION, FIXINGS & FLASHINGS

COLORBOND 'CUSTOM ORB'

- MINIMUM PITCH 5 DEGREES.
- CORROSION PROTECTION IN ACCORDANCE WITH BCA TABLE 3.5.1.1.
- END LAP OF SHEETS

5-15 DEGREES - MINIMUM 200MM.

COLORBOND 'TRIMDEK'

- MINIMUM PITCH 2 DEGREES.
- CORROSION PROTECTION IN ACCORDANCE WITH BCA TABLE 3.5.1.1.
- END LAP OF SHEETS

Date: Int: Accreditation No: CC2211T

2-5 DEGREES - MINIMUM 250MM

ABOVE 15 DEGREES - MINIMUM 150 MM.

- RIDGE LINE VALLEY TO BE TURNED UP (STOP ENDED).
- FASTENERS TO BE MADE OF COMPATIBLE MATERIAL WITH ROOFING MATERIAL.
- CREST FIXINGS OF END SPANS @ EVERY SECOND RIB AND INTERNAL SPANS @ EVERY THIRD RIB.
- WHERE POSSIBLE SHEETS TO BE LAID WITH SIDE LAPS FACING AWAY FROM PREVAILING WEATHER.
- REFLECTIVE FOIL INSULATION TO BE FITTED TO UNDERSIDE OF SHEETS.

R3.5 INSULATION BATTS TO ROOF SPACE ABOVE CEILING LINING.

RECOMMENDED FIXINGS FOR SEVERE EXPOSURE CONDITIONS TO AS 3566

USE CLASS 4 MATERIALS FOR SEVERE EXPOSURE & STAINLESS STEEL FOR VERY SEVERE COASTAL ENVIRONMENTS.

ISSUED FOR APPROVAL

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Client: K. BENNY

Project: PROPOSED DECK & ROOF

Address: 259a MEDEAS COVE ROAD,

ST HELENS

Mob 0417 362 783 or 0417 545 813 **ENGINEERING**

PLUS PROJECT MANAGEMENT
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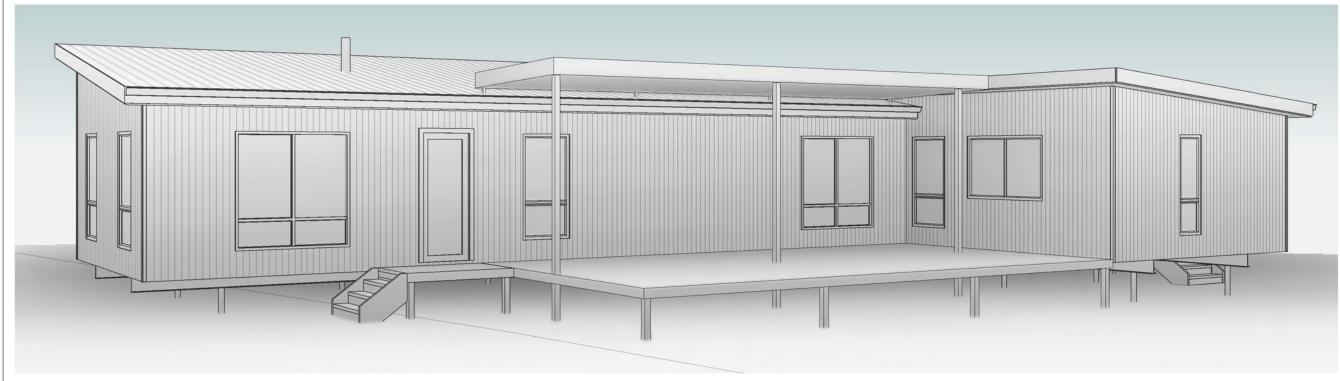
admin@tasbuilthomes.com.au

Date Drawn: 19.03.24 Drawn: O. Jones Checked: O. Jones Approved: J. Pfeiffer Scale: As Shown @ A3 jack@engineeringplus.com.au trin@engineeringplus.com.au Accredited Building Designer 20.03.24 O.J. Designer Name: J.Pfeiffer

A ISSUED FOR APPROVAL

Rev: Amendment:







ISSUED FOR APPROVAL

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Client: K. BENNY

Project: PROPOSED DECK & ROOF

Address: 259a MEDEAS COVE ROAD,

ST HELENS

Approved: J. Pfeiffer
Scale: As Shown @ A3

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jack@engineeringplus.com.au
trin@engineeringplus.com.au

PLUS MARGORITHM DESCRIPTION
PLUS MAR

Accredited Building Designer 20.03.24 O.J. Designer Name: J.Pfeiffer Date: Int: Accreditation No: CC2211T

Date Drawn: 19.03.24

Drawn: O. Jones

Checked: O. Jones

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Rev: Amendment:

Drawing No:

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Rev

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