

Development Applications

Notice is hereby given under Section 57(3) of the Land Use Planning & Approvals Act 1993 that an application has been made to the Break O' Day Council for a permit for the use or development of land as follows:

DA Number DA 2023 / 00235

Applicant J F Titley

Proposal Residential – Change of Use from Shed with Amenities to Dwelling & Construction of

a New Deck

Location 8 Homer Street, St Helens

Plans and documents can be inspected at the Council Office by appointment, 32 - 34 Georges Bay Esplanade, St Helens during normal office hours or online at www.bodc.tas.gov.au.

Representations must be submitted in writing to the General Manager, Break O'Day Council, 32 -34 Georges Bay Esplanade, St Helens 7216 or emailed to admin@bodc.tas.gov.au, and referenced with the Application Number in accordance with section 57(5) of the abovementioned Act during the fourteen (14) day advertised period commencing on Saturday 4 May 2024 until 5pm Friday 17 May 2024.

John Brown **GENERAL MANAGER**

8 Homer st, St.Helens

Client: John Titley

AREAS:
FLOOR AREA 45m²
DECK 28m²
TOTAL 73m²





	No.	Description	Date
P: 0421 745 095 E: info@alldraw.com.au			
l: www.alldraw.com.au			
DP-AD 36943			

Γitle Page				
	Project number	016		
	Date	23/04/2024	01	
	Drawn by	JK		
	Checked by	JT	Scale 1:100	



Description No. Date P: 0421 745 095 E: info@alldraw.com.au I: www.alldraw.com.au DP-AD 36943

Studio Dwelling & New Deck Construction 8 Homer St, St.Helens

Existin	ng Site Plan
	Project number

_	Project number
	Date
	Drawn by
4	01 1 11

016 02 23/04/2024 Scale 1:200 Checked by

 SITE AREA
 705m²

 STUDIO
 45m²

 DECK
 28m²

 TOTAL BUILT AREA
 73m²

SITE COVERAGE - 10%


STORMWATER:


ALL STORMWATER TO BE TAKEN TO THE LEGAL POINT OF DISCHARGE OF THE SITE

ACCORDING TO THE RELEVANT AUTHORITIES APPROVAL. ALL DRAINAGE WORKS IN ACCORDANCE WITH AS3500

WASTE WATER


WASTE WATER TO BE CONNECTED TO EXISTING SEWAGE SYSTEM

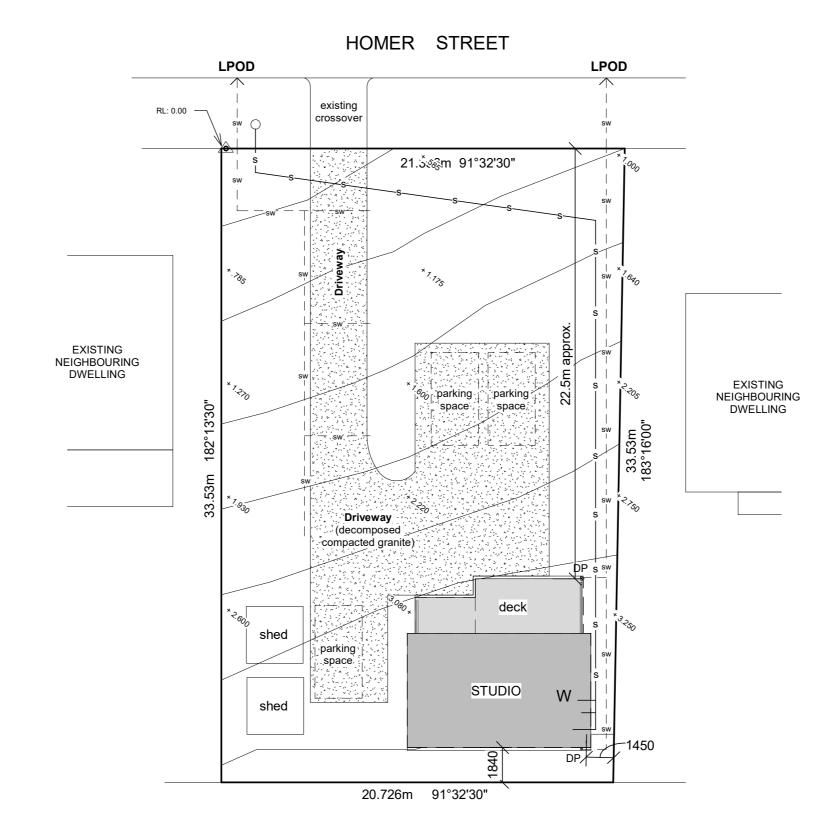


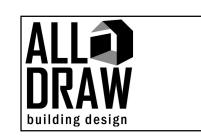

	No.	Description	Date
P: 0421 745 095 E: info@alldraw.com.au I: www.alldraw.com.au DP-AD 36943			
DI -AD 30743			

Proposed Site Plan					
	Project number	016			
	Date	23/04/2024	03		
	Drawn by	JK			
Ψ	Checked by	JT	Sc(As indicated		

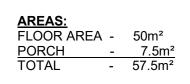

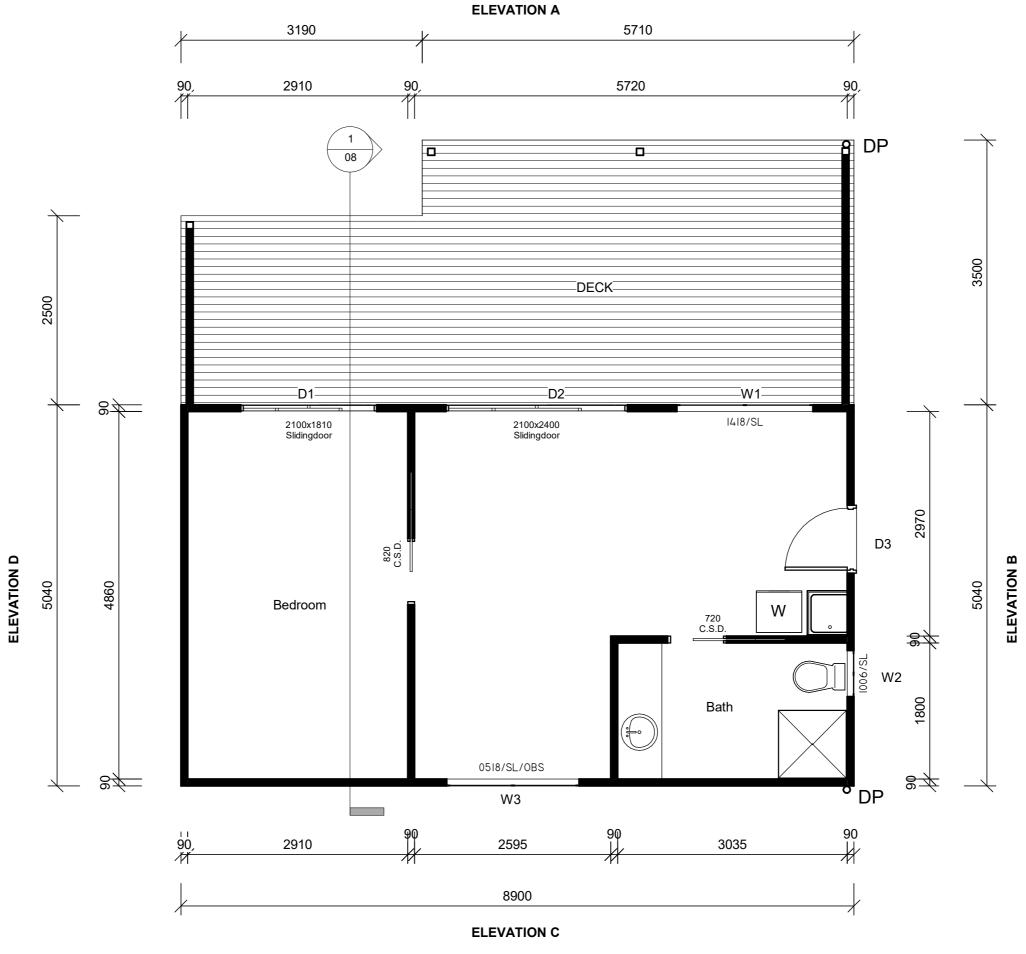



	No.	Description	Date
P: 0421 745 095 E: info@alldraw.com.au			
I: www.alldraw.com.au DP-AD 36943			

Floor Plan					
<u></u>	Project number	016			
	Date	23/04/2024	04	4	
	Drawn by	JK		•	
Ψ	Checked by	JT	Scale	1:50	




1:50

1:50

	No.	Description	Date
P: 0421 745 095			
E: info@alldraw.com.au I: www.alldraw.com.au			
DP-AD 36943			

Elevations					
	Project number	016			
	Date	23/04/2024	05		
	Drawn by	JK			
	Checked by	JT	Scale	1 : 50	

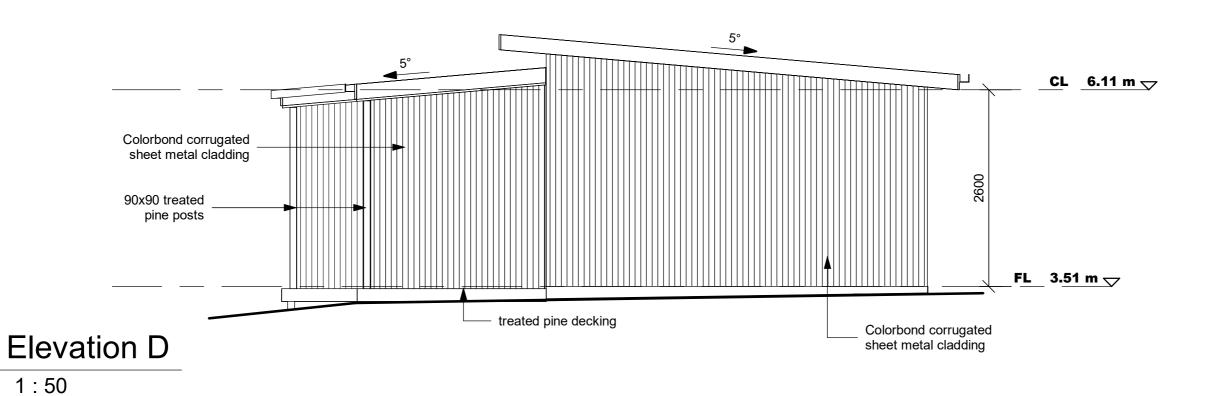



	No.	Description	Date
P: 0421 745 095 E: info@alldraw.com.au			
l: www.alldraw.com.au			
DP-AD 36943			

Elevations					
	Project number	016			
	Date	23/04/2024	06		
	Drawn by	JK			
	Checked by	JT	Scale	1:50	

STORMWATER:

clear polycarbonate roof To stormwater ACCORDING TO THE RELEVANT AUTHORITIES APPROVAL. ALL DRAINAGE WORKS IN ACCORDANCE WITH AS3500 cladding over deck area discharge point DP Colorbond gutter & fascias Corrugated colorbond sheet metal roof cladding @ 5° pitch $\hat{2}$ Colorbond gutter & fascias




	No.	Description	Date
P: 0421 745 095			
E: info@alldraw.com.au I: www.alldraw.com.au			
DP-AD 36943			

Studio Dwelling & New Deck Construction 8 Homer St, St.Helens

DP

Roof Plan				
<u></u>	Project number	016		
	Date	23/04/2024	07	
	Drawn by	JK		
\P	Checked by	JT	S _C (As indicated	

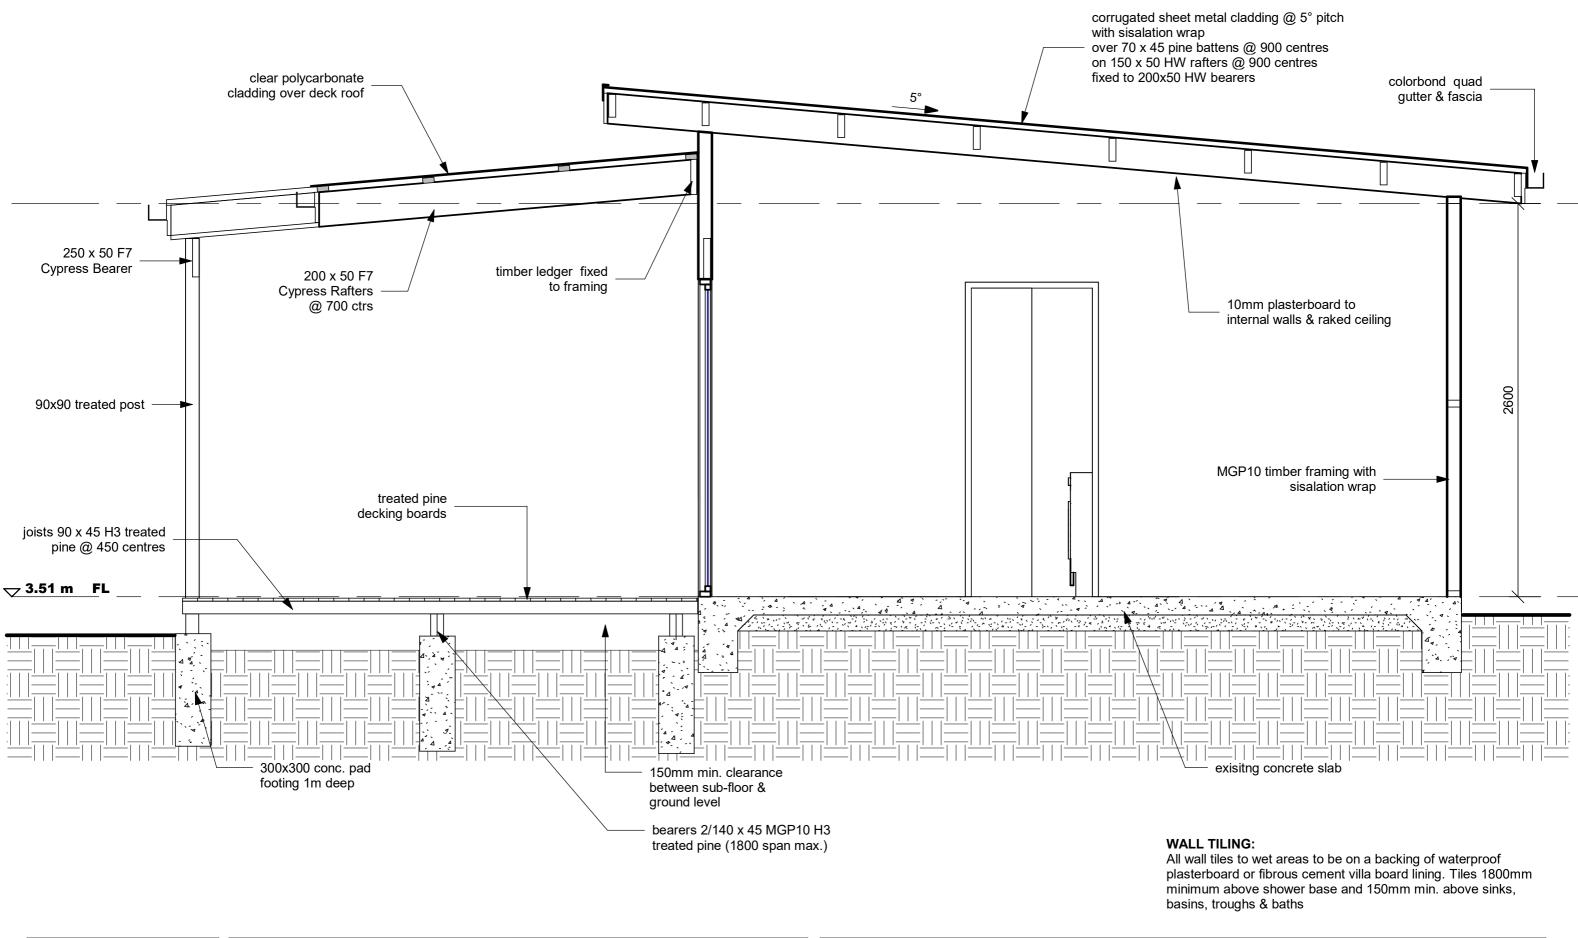




P: 0421 745 095
E: info@alldraw.com.au
I: www.alldraw.com.au
DP-AD 36943

Section				
	Project number	016		
	Date	23/04/2024	0	8
	Drawn by	JK		
	Checked by	JT	Scale	1 : 25

THE LAMP POWER DENSITY OF ARTIFICAL LIGHTING DOES NOT EXCEED: 5W /m² OF FLOOR AREA 4W /m² OF DECK AREA

SMOKE DETECTORS MUST COMPLY W ITH AS 3786 BE INTER-CONNECTED & INSTALLED IN ACCORDANCE WITH B.C.A PART 3.7.2

EXHAUST FAN: EXHAUST VENTILATION FANS ARE TO DISCHARGE THROUGH TO OUTSIDE AIR OR TO A VENTILATED ROOF CAVITY

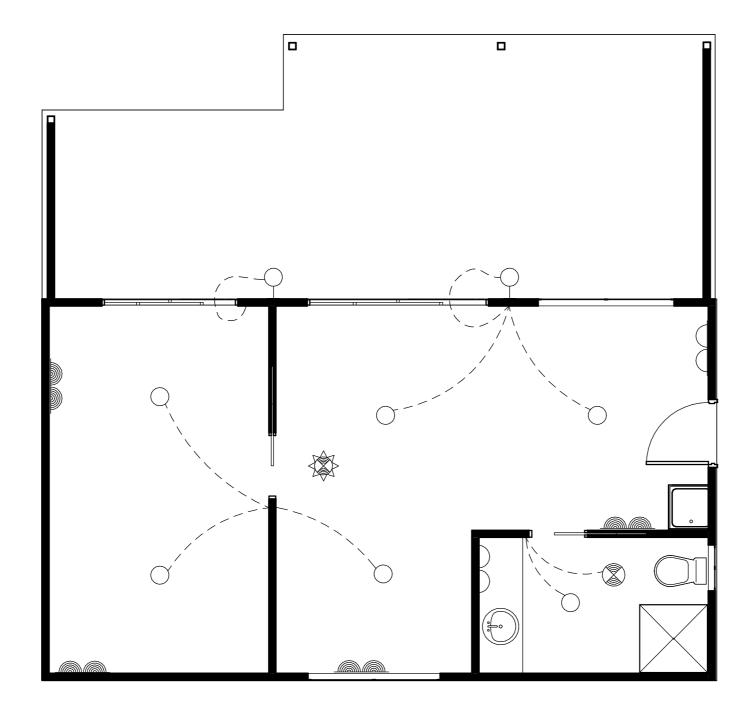

LEGEN

LEGEND	<u>t</u>		
#	T.V. POINT		INTERNET OUTLET
	SINGLE P.P. 300mm above floor		Smoke Detectors as per (AS3786) to be interconnected as per NCC3.7.2.2
	DOUBLE P.P. 300mm above floor	\mapsto	WALL MOUNTED LIGHT 15 watt compact fluro
\triangle	SINGLE P.P. 1100mm above floor	$\models =$	FLUORESCENT TUBE 36 Watt single
	DOUBLE P.P. 1100mm above floor	∇	PARA FLOOD LIGHT 18 watt
	WATERPROOF SINGLE P.P. WATERPROOF DOUBLE P.P.		EXHAUST FAN (SELF CLOSING)
	TV OUTLET	\times	CEILING FAN WITHOUT LIGHT
	LIGHT 15 Watt Compact fluro DOWN LIGHT 11 Watt LED	+	CEILING FAN WITH LIGHT15 watt compact fluro
	FEATURE LIGHT 15 Watt	<u>.</u>	IXL TASTIC (Heat / Light / Fan)
	INFRARED HEATER	AIRCON	AIR-CONDITIONER



	No.	Description	Date
P: 0421 745 095 E: info@alldraw.com.au			
I: www.alldraw.com.au			
DP-AD 36943			


Studio Dwelling & New Deck Construction 8 Homer St, St.Helens


Electrical Layout


	•	
<u></u>	Project number	016
	Date	23/04/2024
	Drawn by	JK
\checkmark	Checked by	JT


09

Sc(As indicated

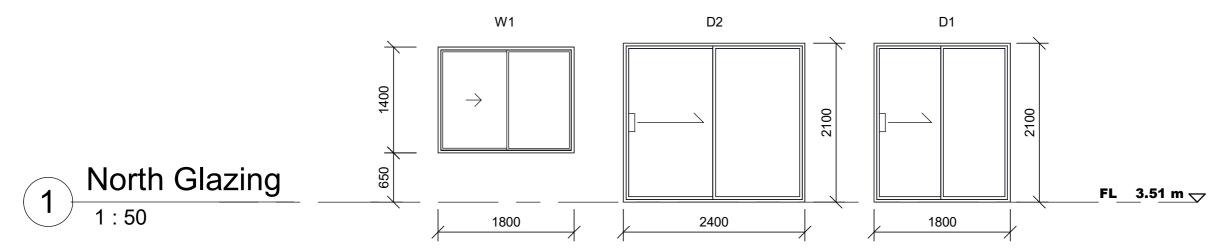

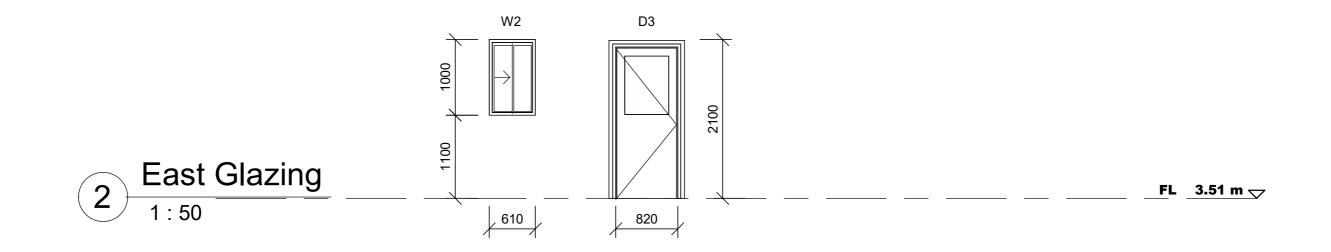

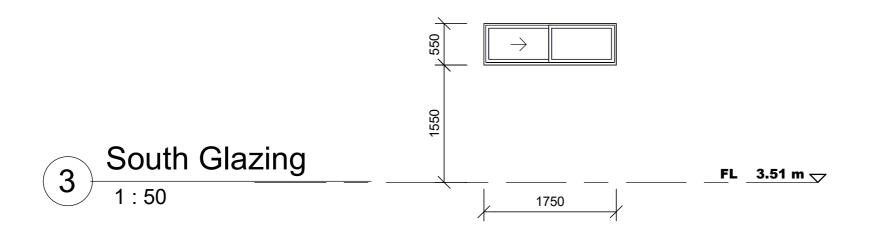

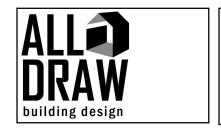

	No.	Description	Date
P: 0421 745 095			
E: info@alldraw.com.au I: www.alldraw.com.au			
DP-AD 36943			

Jiazing Schedule				
	Project number	016		
	Date	23/04/2024	10	
	Drawn by	JK	•	
	Checked by	JT	Scale	1 : 50

GENERAL NOTES:-

GN02 - THE OWNER, BUILDER & SUBCONTRACTOR SHALL VERIFY ALL DIMENSIONS, LEVELS, SETBACKS & SPECIFICATIONS PRIOR TO COMMENCING ANY WORKS OR ORDERING MATERIALS & SHALL BE RESPONSIBLE FOR ENSURING THAT ALL BUILDING WORKS CONFORM TO THE BUILDING CODE OF AUSTRALIA, A.S. CODES (CURRENT EDITIONS) BUILDING REGULATIONS, LOCAL BY-LAWS &

DO NOT SCALE DRAWINGS, USE WRITTEN DIMENSIONS ONLY.

TOWN PLANNING REQUIREMENTS.

FIGURED DIMENSIONS TAKE PRECEDENCE OVER SCALED

DIMENSIONS

GN01 -

GN03 - ALL WORKS SHALL COMPLY WITH BUT NOT BE LIMITED TO THE FOLLOWING AUSTRALIAN STANDARDS:

A.S. 1288 GLASS IN BUILDINGS - SELECTION & INSTALLATION

A.S. 1562 - DESIGN & INSTALLATION OF SHEET ROOF & WALL

CLADDINGS. - PART 1 METAL.

A.S. 1684.2 - NATIONAL TIMBER FRAMING CODE.

A.S. 2870 - RESIDENTIAL SLABS AND FOOTINGS. - CONSTRUCTION.

A.S. 2904 - DAMP-PROOF COURSES AND FLASHING.

A.S. 3600 - CONCRETE STRUCTURES.

A.S. 3660.1 - PROTECTION OF BUILDING AGAINST SUBTERRANEAN TERMITES

PART 1 NEW BUILDINGS.

A.S. 3700 - MASONRY IN BUILDINGS.

A.S. 3740 - WATERPROOFING OF WET AREAS IN RESIDENTIAL BUILDINGS.

A.S. 3786 - SMOKE ALARMS.

A.S. 4055 - WIND LOADINGS FOR HOUSING.

GN04 - THESE PLANS SHALL BE READ IN CONJUNCTION WITH ANY STRUCTURAL OR CIVIL ENGINEERING COMPUTATIONS &

DRAWINGS.

GN05 - SOIL CLASSIFICATION.

THESE PLANS SHALL BE READ IN CONJUNCTION WITH THE:-

SOIL REPORT

FOOTINGS TO BE FOUNDED AT THE MINIMUM DEPTHS INDICATED

IN THE SOIL REPORT.

GN06 WHERE THE BUILDING (OTHER THAN A CLASS 10a) IS LOCATED IN A DESIGNATED TERMITE INFESTATION AREA THE BUILDING SHALL

BE PROTECTED IN ACCORDANCE WITH A.S.3660.1

FRAMING SCHEDULE

WALL FRAMING

TOP AND BOTTOM PLATES 90 x 45 MGP10 STUDS AT 450 CENTRES 90 x 45 MGP10

JAMB STUDS

OPENINGS UP TO 900 2/90 x 45 MGP10
OPENINGS UP TO 1810 2/90 x 45 MGP10
OPENINGS UP TO 2700 4/90 x 45 MGP10

OPENINGS UP TO 3600 4/90 x 45 MGP10

LINTELS

 OPENINGS UP TO 900
 2/90 x 45
 MGP10

 OPENINGS UP TO 1450
 2/140 x 45
 MGP10

 OPENINGS UP TO 1810
 190 x 45
 MGP10

 OPENINGS UP TO 1810
 190 x 45
 MGP10

OPENINGS UP TO 3600 2/240 x 45 MGP10

TIMBER FRAMING TO COMPLY WITH A.S.1684 TIMBER FRAMING CODE & ANY SUPPLEMENTARY TABLES GN07 - ALL GLAZING 500mm ABOVE FLOOR LEVEL TO COMPLY WITH A.S. 1288-2006

GN08 - WINDOW SIZES ARE NOMINAL ONLY, ACTUAL SIZE WILL VARY ACCORDING TO MANUFACTURER. WINDOWS TO BE FLASHED ALL

GN09 - STORMWATER SHALL BE TAKEN TO LEGAL POINT OF DISCHARGE

TO THE SATISFACTION OF THE RELEVANT AUTHORITY.

GN10 - SEWER OR SEPTIC SYSTEM SHALL BE IN ACCORDANCE WITH THE RELEVANT AUTHORITY'S REQUIREMENTS.

GN11 - FOOTINGS NOT TO ENCROACH TITLE BOUNDARIES AND EASEMENT LINES.

GN12 - SMOKE ALARMS COMPLY WITH A.S. 3786 AND

INSTALLED IN ACCORDANCE WITH B.C.A. Vic appd, PART E CI E 1.7.7 THE SMOKE ALARM SHALL BE HARD WIRED WITH BATTERY BACKUP.

GN13 - WATERPROOFING TO FLOORS & WALLS OF WET AREAS TO BE PROVIDED IN ACCORDANCE WITH B.C.A. PART 3.8 AND COMPLY WITH A.S.3740

GN14 - PROVIDE WALL TIES TO BRICKWORK AT MAXIMUM 450mm CENTRES IN EACH DIRECTION AND WITHIN 300mm OF

ARTICULATION JOINTS.

GN15 - ALL WALL TILING TO WET AREAS ARE TO BE ON A BACKING OF WATERPROOF PLASTERBOARD OR FIBROUS CEMENT VILLABOARD LINING

TILES TO BE 1800mm MIN. ABOVE SHOWER BASE TILES TO BE 150mm MIN. ABOVE SINKS, BASINS, TROUGHS & BATHS

GN16 - EXHAUST VENTILATION FANS TO EXHAUST TO OUTSIDE AIR OR OUT TO VENTILATED ROOF CAVITY

GN17 - THERMAL INSULATION TO BE PROVIDED IN ACCORDANCE

WITH THE ENERGY RATING REPORT


GN18 - THE BUILDER SHALL TAKE ALL STEPS NECESSARY TO ENSURE THE STABILITY OF NEW & EXISTING STRUCTURES DURING ALL

WORKS.


GN19 - THE BUILDER SHALL ENSURE THE GENERAL WATER TIGHTNESS

OF ALL NEW & EXISTING WORKS.

CORNER WALL FLASHING DETAIL

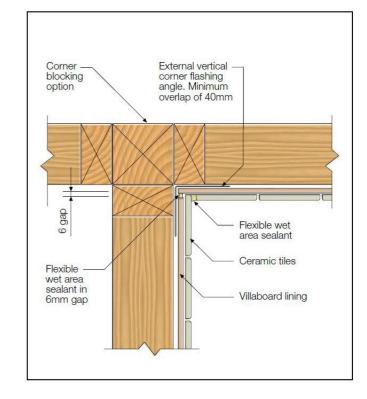

SPLASHBACK DETAIL

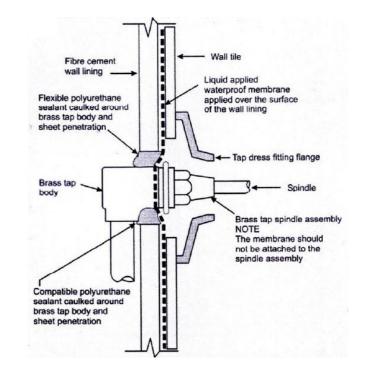



General Notes				
	Project number	016		
	Date	23/04/2024	11	
	Drawn by	JK		
	Checked by	JT	Scale	