32-34 Georges Bay Esplanade St Helens Tasmania 7216 T: 03 6376 7900 ABN 96 017 131 248



Development Applications

Notice is hereby given under Section 57(3) of the Land Use Planning & Approvals Act 1993 that an application has been made to the Break O' Day Council for a permit for the use or development of land as follows:

DA Number DA 2025 / 00075 **Applicant Engineering Plus**

Proposal Residential (other) – Retrospective Approval of Annex

Location 10 Chimney Heights Road, Stieglitz (Site 11)

Plans and documents can be inspected at the Council Office by appointment, 32 - 34 Georges Bay Esplanade, St Helens during normal office hours or online at www.bodc.tas.gov.au.

Representations must be submitted in writing to the General Manager, Break O'Day Council, 32 -34 Georges Bay Esplanade, St Helens 7216 or emailed to admin@bodc.tas.gov.au, and referenced with the Application Number in accordance with section 57(5) of the abovementioned Act during the fourteen (14) day advertised period commencing on Saturday 5th July, 2025 until 5pm Friday 18th July, 2025.

John Brown **GENERAL MANAGER**



As Constructed Annexe

Xu Family Group 2 Pty Ltd Site 11, 10 Chimney Heights Road, Stieglitz TAS 7216

Planning Development Report

prepared for

Break O'Day Council

prepared by

Jun Ren

EngineeringPlus Pty. Ltd. House Plans Plus Pty. Ltd.

81 Elizabeth Street - Launceston

Mobile: 0438 717 048

 $\begin{tabular}{ll} Website: & \underline{www.engineeringplus.com.au} \\ Email: & \underline{jun@engineeringplus.com.au} \\ \end{tabular}$



Overview

This written planning scheme response has been prepared in response to the request for further information regarding the as constructed annexe located in a caravan park. It addresses the relevant planning scheme provisions and ensures that any changes required are reflected in the accompanying amended plans.

Description

Property Details

PID: 6788804

Lot Size: 13400m²

Zoning: 8 – General Residential

Zone

Vegetation: Existing vegetation on

site to be retained.

Type: Class 10a

Stories: Single

Bedrooms: -

Foundation: Concrete

Walls: Colorbond

Roof: Colorbond

Area:

As Constructed Annexe: 18m²





Contents

This submission is to be read in conjunction with the following plans:

Architectural Plans by Engineering Plus:

A00 – Cover Page	Rev. B
A01 – Locality Plan and Site Plan	Rev. B
A02 – Floor Plan	Rev. B

Applicant

Submission of this application by Engineering Plus is on behalf of:

Xu Family Group 2 Pty Ltd Site 11, 10 Chimney Heights Road, Stieglitz TAS 7216



8.0 General Residential Zone

8.5 Development Standards for Non-dwellings

8.5.1 non-dwelling development

Objectives:

That all non-dwelling development:

- (a) is compatible with the character, siting, apparent scale, bulk, massing and proportion of residential development; and
- (b) does not cause an unreasonable loss of amenity on adjoining residential properties.

P1 - Performance Criteria

A building that is not a dwelling, excluding for Food Services and local shop, must have a setback from a frontage that is compatible with the streetscape, having regard to any topographical constraints.

Response:

The as-constructed annexe at Site 11, 10 Chimney Heights Road, Stieglitz TAS 7216 has a boundary setback of 2710mm and a frontage setback of 1200mm, relative to the neighbouring building and the adjacent caravan parking area. These setbacks have been carefully considered to ensure compatibility with the existing streetscape character.

The neighbouring building and the caravan parking area have frontage setbacks of 1400mm and 1800mm respectively. Notably, the frontage of the caravan and the neighbouring building are generally aligned, contributing to a consistent building line along the street.

Despite the slightly reduced frontage setback of the annexe, its position remains visually compatible with the existing built form and does not result in any adverse impact on the rhythm or coherence of the streetscape. The increased side setback of the annexe further assists in minimising bulk, maintaining openness, and ensuring amenity for adjoining sites.









BRE-S2.0 Stormwater Management Specific Area Plan

BRE-S2.7 Development Standards for Buildings and Works

BRE-S2.7.1 Stormwater management

Objectives:

(a) That development provides for adequate stormwater management.


A1 – Acceptable Solutions

Development must be:

- (a) capable of connecting to the public stormwater system; or
- (b) permitted by the General Manager to discharge stormwater to a system other than the public stormwater system.

Response:

The sewer and stormwater from the as-constructed annexe at Site 11, 10 Chimney Heights Road, Stieglitz TAS 7216 are connected to existing sewer and stormwater systems on site. The existing sewer and stormwater systems of Hillcrest Caravan Park runs along the boundary line in between the boundary and the as constructed annexe.

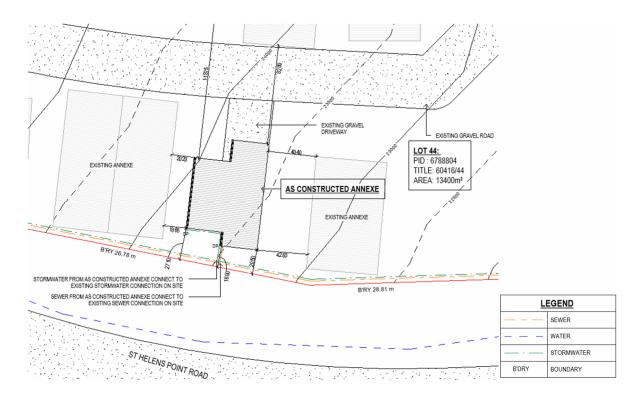



Conclusion

In consideration of the information provided and the specific measures implemented, it is evident that the as-constructed annexe located at Site 11, 10 Chimney Heights Road, Stieglitz TAS 7216 will not impact the established streetscape along St Helens Point Road. The annexe is appropriately sited and designed to maintain visual harmony with the surrounding built environment.

Additionally, the sewer and stormwater services for the annexe have been correctly connected to the existing on-site infrastructure, ensuring proper functionality and compliance with servicing requirements.

We appreciate your time and attention in assessing this application. Should you require any further information or clarification, please do not hesitate to contact us.

Best regards,

Jack & Trin Pfeiffer

Directors

EngineeringPlus Pty. Ltd. **House Plans Plus Pty. Ltd**

81 Elizabeth Street, Launceston

Jack: 0417 362 783 Email: jack@engineeringplus.com.au

Trin: 0417 545 813 Email: trin@engineeringplus.com.au

Accreditation No. CC2211T



DRAWING SCHEDULE

A00 COVER PAGE A01 SITE PLAN A02 FLOOR PLAN

PROJECT INFORMATION

BUILDING DESIGNER: GRANT JAMES PFEIFFER

ACCREDITATION No: CC2211T

ZONE: 8.0 GENERAL RESIDENTIAL ZONE

BUILDING CLASS:

LAND TITLE REFERENCE NUMBER:

DESIGN WIND SPEED:

SOIL CLASSIFICATION:

CLASS 10

60416/44

ASSUMED "N2"

ASSUMED "H1"

CLIMATE ZONE: 7
BUSHFIRE-PRONE BAL RATING: N/A
ALPINE AREA: N/A
CORROSION ENVIRONMENT: SEVERE
FLOODING: NO

LANDSLIP: NO
DISPERSIVE SOILS: UNKNOWN
SALINE SOILS: UNKNOWN

SAND DUNES: NO MINE SUBSIDENCE: NO LANDFILL: NO

GROUND LEVELS: REFER PLAN

ORG LEVEL: 75mm ABOVE GROUND LEVEL

AS CONSTRUCTED ANNEXE


XU FAMILY GROUP 2 PTY LTD 10 CHIMNEY HEIGHTS ROAD, STIEGLITZ TAS 7216


BREAK O'DAY COUNCIL

ISSUED FOR DEVELOPMENT APPROVAL

DEVELOPMENT AREA		
Name	Area	
AS CONSTRUCTED ANNEXE	18.00 m²	
	10 00 m²	

18.00 m²

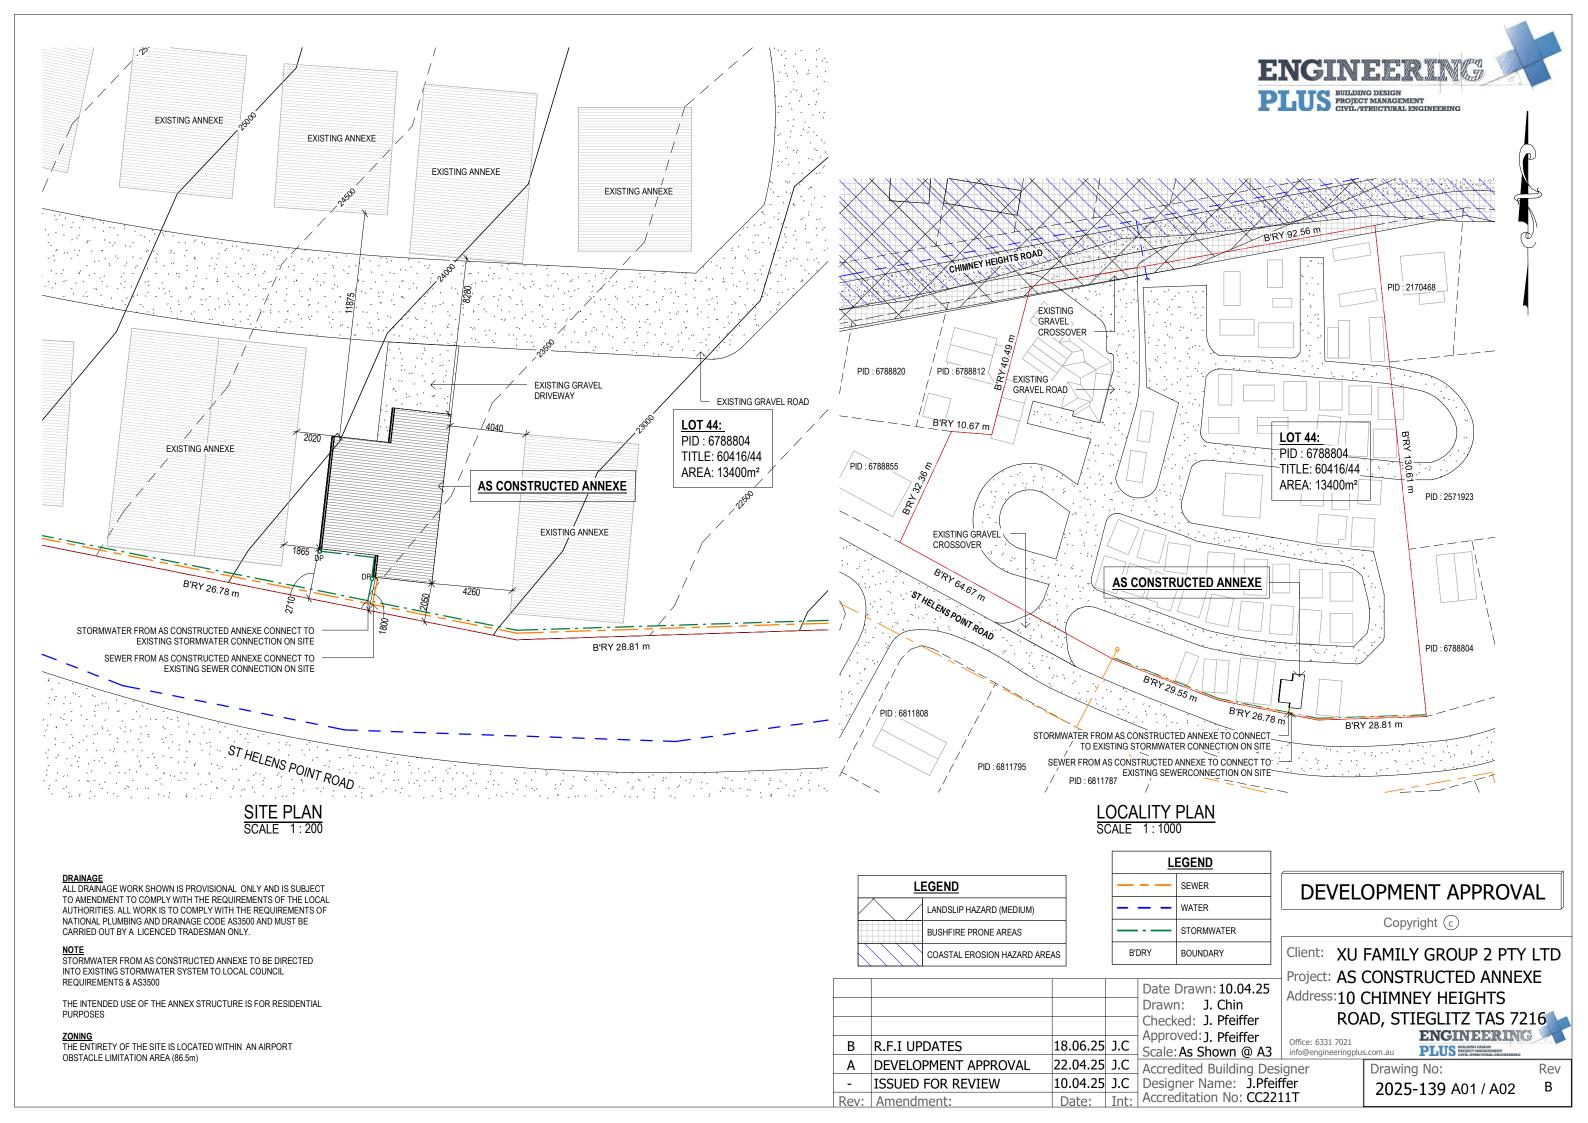

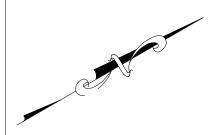

ALL DRAINAGE WORK SHOWN IS PROVISIONAL ONLY AND IS SUBJECT TO AMENDMENT TO COMPLY WITH THE REQUIREMENTS OF THE LOCAL AUTHORITIES.

ALL WORK IS TO COMPLY WITH THE REQUIREMENTS OF AS/NZS 3500 & THE TASMANIAN PLUMBING CODE. AND MUST BE CARRIED OUT BY A LICENCED TRADESMAN ONLY.

LEGEND OF DIAMETERS TROUGH = 50mm

SINK = 50mm BATH = 40mm

BASIN = 40mm

SHOWER = 50mm WC = 100mm

SEWER = 100mm DIA. uPVC

ORG OVERFLOW RELIEF GULLY

EV VENT DP DOWNPIPE 90mm DIA


STORMWATER = 100mm DIA uPVC

THE INSTALLATION OF WATER PIPE LINES, INSTALLED WITH THE PRODUCT HIS 311 REHAU. WILL REQUIRE THE MAIN COLD WATER LINE TO BE DN 25mm WITH DN 16mm BRANCHES & HOT WATER MAIN LINES TO BE DN 20mm WITH DN 16mm BRANCHES TO FIXTURES, ALL OTHER PRODUCTS USED ARE TO COMPLY WITH THE REQUIREMENTS OF AS/NZS 3500.5.2021 & AS/NZS 3500.1.2021

HOT WATER INSTALLATION SHALL DELIVER HOT WATER TO ALL SANITARY FIXTURES USED FOR PERSONAL HYGIENE AT 50deg C, KITCHEN SINK & LAUNDRY SHALL BE 60deg C TO COMPLY WITH REQUIREMENTS OF AS/NZS 3500.5.2021 SECTION 3.4

PLUMBING FIXTURE	ABBREVIATION
BASIN	В
BATH	втн
SHOWER	SHR
CLOTHES WASHING MACHINE	CWM
DISHWASHING MACHINE	DWM
FLOOR WASTE GULLY	FWG
OVERFLOW RELIEF GULLY	ORG
HOT WATER CYLINDER	HWC
SINK	S
TROUGH, LAUNDRY	TR(L)
WATER CLOSET PAN	W.C
INSPECTION OPENING	10
DOWNPIPE	DP

Area Schedule (Gross Building)		
Name	Area	Area (sq)
AS CONSTRUCTED ANNEXE	18.00 m ²	1.94
	18.00 m ²	1.94

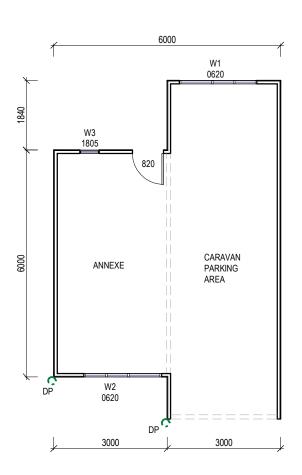

FLOOR PLAN SCALE 1:100

R.F.I UPDATES

Rev: Amendment:

DEVELOPMENT APPROVAL

ISSUED FOR REVIEW



WINDOW SCHEDULE

MARK HEIGHT WIDTH TYPE U-VALUE SHGC

W1	600	2050	DG	4.3	0.55
W2	600	2050	DG	4.3	0.55
W3	1800	500	DG	4.3	0.55

DISCLAIMER

ALL WINDOWS SHOWN ON PLAN ARE APPROX. BASED OFF STANDARD MANUFACTURING SIZES. ALL WINDOW DIMENSIONS TO BE CONFIRMED ON SITE BY BUILDER PRIOR TO ORDERING AND MANUFACTURING.

		FLOOR COVERINGS	
			CARPET
<u>L</u> l	<u>EGEND</u>	- A A	CONCRETE
	SEWER		TIMBER DECKING
	WATER		TIMBER DECKING
	STORMWATER		TILE
B'DRY	BOUNDARY		VINYL TIMBER FLOORING

DEVELOPMENT APPROVAL

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Client: XU FAMILY GROUP 2 PTY LTD

Project: AS CONSTRUCTED ANNEXE

Address: 10 CHIMNEY HEIGHTS

ROAD, STIEGLITZ TAS 7216 ENGINEERING

info@engineeringplus.com.au

PLUS BUILDING DESIGN
PROJECT MANAGEMENT
GIVIL/STRUCTURAL ENGI Drawing No:

Accredited Building Designer 10.04.25 J.C | Designer Name: J.Pfeiffer Date: Int: Accreditation No: CC2211T

Date Drawn: 10.04.25

Drawn: J. Chin

18.06.25 J.C

22.04.25 J.C

Checked: J. Pfeiffer Approved: J. Pfeiffer

Scale: As Shown @ A3

2025-139 A02 / A02

Rev В