32-34 Georges Bay Esplanade St Helens Tasmania 7216 T: 03 6376 7900 ABN 96 017 131 248



Development Applications

Notice is hereby given under Section 57(3) of the Land Use Planning & Approvals Act 1993 that an application has been made to the Break O' Day Council for a permit for the use or development of land as follows:

DA Number DA 2025 / 00097

Applicant P Davis

Proposal Residential - Construction of a Shed

Location 12 Ti-Tree Drive, Ansons Bay

Plans and documents can be inspected at the Council Office by appointment, 32 - 34 Georges Bay Esplanade, St Helens during normal office hours or online at www.bodc.tas.gov.au.

Representations must be submitted in writing to the General Manager, Break O'Day Council, 32 -34 Georges Bay Esplanade, St Helens 7216 or emailed to admin@bodc.tas.gov.au, and referenced with the Application Number in accordance with section 57(5) of the abovementioned Act during the fourteen (14) day advertised period commencing on Saturday 13th September 2025 until 5pm Friday 26th September 2025.

John Brown **GENERAL MANAGER**

DWG NO.	DRAWING	REV
A000	COVER PAGE	03
A103	SITE PLAN SHED	01
A204	PLAN / ROOF PLAN / ELEVATIONS	01
A607	DOOR / WINDOW SCHEDULE	01
SCH03	WORKPLACE HEALTH & SAFETY	01
SCH04	WORKPLACE HEALTH & SAFETY	01

NEW SHED 12 TI-TREE DRIVE ANSONS BAY

NCC BUILDING CLASSIFICATION(S):

CLASS 10a (GARAGE)

BAL ASSESSMENT: (AS3959-2018)

EX. FLOOR AREA: 114.6m²
NEW GROUND FLOOR: 54m²
NEW FIRST FLOOR: NAm²
TOTAL AREA: 168.60m²

DECKS, RAMPS, ETC: 41.9m²

PLANNING ZONE: BODC 12 LOW DENSITY RES

LAND TITLE REF: 12275/16

PROPERTY ID: 681

SOIL CLASSIFICATION: S

6810362

(AS2870-2011)

WIND CLASSIFICATION: N3 (AS4055-2012)

CLIMATE ZONE: (NCC 2019)

ALPINE AREA:

(NCC 2019)

CORROSION ENV: (AS4312-2008)

DRAWINGS TO BE READ IN
CONJUNCTION WITH ANY WRITTEN
SPECIFICATIONS AND ANY
ASSOCIATED DOCUMENTATION
PREPARED BY SUB-CONSULTANTS

BOUNDARY INFORMATION AND CONTOURS HAVE BEEN SOURCED FROM THE LIST AND ELVIS FOUNDATION SPATIAL DATA AND IS APPROXIMATE.

WRITTEN DIMENSIONS TAKE PRECEDENCE OVER SCALED DIMENSIONS

DIMENSIONS IN MILLIMETRES UNLESS NOTED OTHERWISE

DOCUMENTATION IS SUBJECT TO STATUTORY APPROVALS

THIS DESIGN IS INTENDED TO BE BUILT ONLY ONCE AND ONLY ON THE SITE THAT THE DESIGN WAS PREPARED FOR

IMPORTANT

WORKS ARE TO BE IN ACCORDANCE WITH THE APPLICABLE AUSTRALIAN STANDARDS, CONSTRUCTION CODES (NCC) & REQUIREMENTS OF ANY RELEVANT LOCAL AUTHORITIES





 NORTH

NEW SHED

12 TI-TREE DRIVE ANSONS BAY TAS P DAVIS & L KENNY

SCALE: **(A3)**

REV	AMENDMENT	DATE	ISSUED BY:
01	DA / REVIEW	27/04/2023	Idavis
02	BA / REVIEW	17/07/2023	DRAWN BY:
03	FOR REVIEW	27/05/2025	LD
03	APPROVAL	21100/2020	APPROVED BY:
			СВМ
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COVER PAGE

DWG: **A000**PROJECT: **EE642**

FOR CONSTRUCTION

REV: **03**









CBM Sustainable Design

51 York Street, PO Box 1971, Launceston TAS 7250 NORTH

NEW SHED 12 TI-TREE DRIVE ANSONS BAY TAS P DAVIS & L KENNY


REV AMENDMENT DATE ISSUED BY: Idavis FOR REVIEW 27/05/2025 APPROVAL DRAWN BY: LD APPROVED BY: PROJECT: **EE642** SCALE: 1:500 (A3) СВМ

SITE PLAN SHED DWG: **A103**

FOR CONSTRUCTION

REV: 01



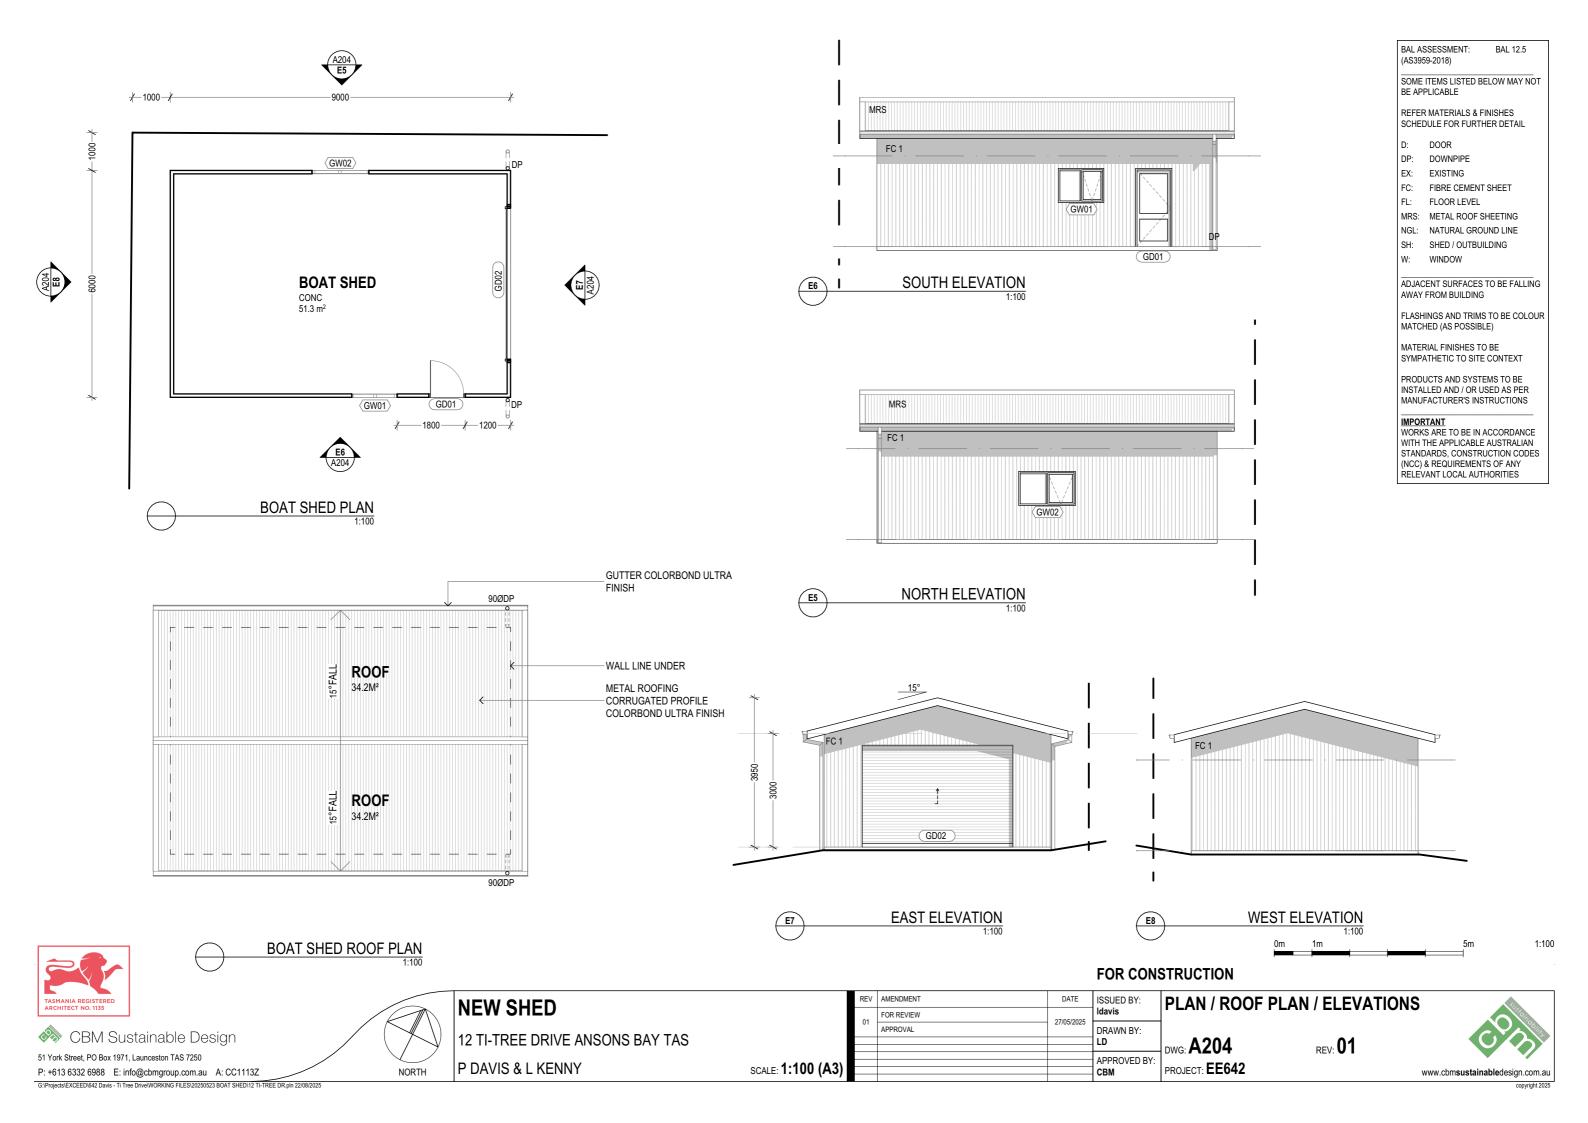

DOOR SCHEDULE										
DOOR NO.:	GD01	GD02								
STORY:	GROUND FLOOR	GROUND FLOOR								
LOCATION:	BOAT SHED	BOAT SHED								
POSITION	Exterior	Exterior								
BUSHFIRE ATTACK LEVEL	BAL 12.5	BAL 12.5								
DOOR TYPE:	HINGE	ROLLER DOOR								
WIDTH x HEIGHT:	900×2040	4000×2700								
NOMINAL SILL HT.:	0	0								
EXTERIOR VIEW: (NOT TO SCALE)	*-900- *	4000								
FRAME: (MATERIAL / FINISH)	ALUMINIUM POWDERCOAT IRONSTONE	COLORBOND IRONSTONE								
LEAF: (MATERIAL / FINISH)	CONFIRM WITH OWNER	COLORBOND IRONSTONE								
SPECIFIC NOTES:										

WINDOW SCHEDULE											
WINDOW NO.:	GW01	GW02									
STORY:	GROUND FLOOR	GROUND FLOOR									
LOCATION:	BOAT SHED	BOAT SHED									
BAL RATING:	BAL 12.5	BAL 12.5									
WIDTH x HEIGHT:	1200×900	1500×900									
NOMINAL SILL HT.:	1170	900									
OPERABLE SASH:	AWNING	AWNING									
EXTERIOR VIEW: (NOT TO SCALE)	↑ 006 ↑ 1200 ↑	* 1500 *									
FRAME: (MATERIAL / FINISH)	ALUMINIUM POWDERCOAT IRONSTONE	ALUMINIUM POWDERCOAT IRONSTONE									
GLAZING: (MATERIAL / FINISH)	CONFIRM WITH OWNER	CONFIRM WITH OWNER									
SPECIFIC NOTES:	CONFIRM WITH OWNER	CONFIRM WITH OWNER									

DOOR SCHEDULE

WINDOW SCHEDULE

SCALE: (A3)





 NORTH

NEW SHED

12 TI-TREE DRIVE ANSONS BAY TAS P DAVIS & L KENNY

FOR CONSTRUCTION

DOOR / WINDOW SCHEDULE

DWG: **A607**PROJECT: **EE642**

REV: **01**



GENERAL

- 1. THE FOLLOWING RISK MITIGATION NOTES HAVE BEEN PREPARED TO ADVISE THE 'PERSON CONDUCTING A BUSINESS OR UNDERTAKING' (PCBU) ON THE HEALTH AND SAFETY ASPECTS OF THE DESIGN IN ACCORDANCE WITH THE WORK HEALTH AND SAFETY ACT 2011 AND ARE PERTINENT TO ANY TIME WHEN THE BUILDING OPERATES AS A WORKPLACE.
- 2. THESE NOTES MAY NOT NECESSARILY ACCOUNT FOR ALL CONSTRUCTION. OPERATION. MAINTENANCE AND DEMOLITION PRACTICES AND SAFETY RISKS. INCLUSION OR EXCLUSION OF ANY ITEM DOES NOT ABSOLVE THE OWNER, CONTRACTOR, USER, MAINTAINER OR DEMOLISHER OF THEIR OBLIGATIONS TO UNDERTAKE APPROPRIATE RISK MANAGEMENT ACTIVITIES AND IT IS NOT AN ADMISSION THAT ANY ITEM BELOW IS THE RESPONSIBILITY OF THE DESIGNER.
- 3. ADDITIONAL GUIDANCE ON WORKPLACE HEALTH AND SAFETY IS PROVIDED IN THE FOLLOWING CODES OF PRACTICE, WHICH THE CONTRACTOR IS TO COMPLY WITH AS APPLICABLE:
- "CONSTRUCTION WORK" (CP104);
- "HOW TO MANAGE WORK HEALTH AND SAFETY RISKS" (CP112);
- "MANAGING THE WORK ENVIRONMENT AND FACILITIES" (CP124):
- "SAFE DESIGN OF STRUCTURES" (CP127).
- 4. FURTHER ADDITIONAL AND UPDATED CODES OF PRACTICE AND OTHER GUIDANCE MATERIALS FOR THE MINIMISATION OF RISKS TO WORKPLACE HEALTH AND SAFETY ARE MADE AVAILABLE PERIODICALLY FROM SAFE WORK AUSTRALIA (www.safeworkaustralia.gov.au) AND THE RELEVANT STATE SAFE WORKING AUTHORITIES AND SHOULD BE CONSULTED PRIOR TO WORKS COMMENCING ON SITE.
- 5. WHERE APPLICABLE, THE SPECIFIC RISKS ASSOCIATED WITH THIS PROJECT HAVE BEEN ASSESSED AND ARE SUMMARISED WHERE APPLICABLE, IN THE ATTACHED RISK
- 6. IT IS THE CONTRACTOR'S RESPONSIBILITY TO IDENTIFY ALL ASSOCIATED RISKS OF THE CONSTRUCTION PROCESS AND TO PREPARE ADEQUATE SAFE WORK METHOD STATEMENTS AND JOB SAFETY ANALYSIS.
- 7. TEMPORARY STRUCTURES AND CONTRACTOR ERECTION PROCEDURES ARE ONLY INDICATED WHERE ESSENTIAL TO THE EXECUTION OF THE DESIGN AS INTENDED IN THE DOCUMENTS PROVIDED. DETAILED PROCEDURES MUST BE SOUGHT PRIOR TO WORKS COMMENCING. FOR ALL ASSOCIATED TEMPORARY STRUCTURE OR ERECTION DESIGN AND CERTIFICATION THE CONTRACTOR IS TO ENGAGE A THIRD PARTY TO ASSIST, CERTIFY AND OVERSEE THE ERECTION OF THE WORKS.

RUPTURE OF SERVICES DURING EXCAVATION FOR OTHER ACTIVITY CREATES A VARIETY OF RISKS INCLUDING RELEASE OF HAZARDOUS MATERIAL. EXISTING SERVICES MAY BE LOCATED ON OR AROUND THE BUILDING SITE. WHERE KNOWN, THESE ARE IDENTIFIED ON THE DRAWINGS; HOWEVER THE EXACT LOCATION AND EXTENT OF SERVICES MAY VARY FROM THAT INDICATED. SERVICES SHOULD BE LOCATED USING AN APPROPRIATE SERVICE, APPROPRIATE EXCAVATION PRACTICE SHOULD BE USED AND, WHERE NECESSARY, SPECIALIST CONTRACTORS SHOULD BE ENGAGED.

SITE ACCESS / TRAFFIC MANAGEMENT:

- 1. THE CONTRACTOR IS TO CONDUCT WORKS IN ACCORDANCE WITH THE CODE OF PRACTICE: "TRAFFIC MANAGEMENT IN WORKPLACES" STANDARD CONTROL.
- 2. ESPECIALLY FOR BUILDINGS ON A MAJOR, NARROW, OR STEEPLY INCLINED ROAD: PARKING OF VEHICLES OR LOADING / UNLOADING OF VEHICLES ON THE ROADWAY MAY CAUSE A TRAFFIC HAZARD, DURING CONSTRUCTION, MAINTENANCE OR DEMOLITION OF THE BUILDING, DESIGNATED PARKING FOR WORKERS AND LOADING AREAS SHOULD BE PROVIDED, WHERE APPLICABLE, A TRAFFIC MANAGEMENT PLAN SUPERVISED BY TRAINED TRAFFIC MANAGEMENT PERSONNEL SHOULD BE IMPLEMENTED FOR THE WORK SITE.
- 3. PUBLIC ACCESS TO CONSTRUCTION AND DEMOLITION SITES AND TO AREAS UNDER MAINTENANCE CAUSES RISK TO WORKERS AND THE PUBLIC. WARNING SIGNS AND SECURE BARRIERS TO UNAUTHORISED ACCESS SHOULD BE PROVIDED. WHERE ELECTRICAL INSTALLATIONS, EXCAVATIONS, PLANT OR LOOSE MATERIALS ARE PRESENT, THEY SHOULD BE SECURED WHEN NOT FULLY SUPERVISED.
- 4. BUILDING OWNERS AND OCCUPIERS SHOULD MONITOR THE PEDESTRIAN ACCESS WAYS AND, IN PARTICULAR, ACCESS TO AREAS WHERE MAINTENANCE IS ROUTINELY CARRIED OUT, TO ENSURE THAT SURFACES HAVE NOT MOVED OR CRACKED SUCH THAT THEY BECOME UNEVEN AND PRESENT A TRIP HAZARD. SPILLS, LOOSE MATERIAL, STRAY OBJECTS OR ANY OTHER MATTER THAT MAY CAUSE A SLIP OR TRIP HAZARD SHOULD BE CLEANED OR REMOVED FROM ACCESS WAYS.
- 5. CONTRACTORS SHOULD BE REQUIRED TO MAINTAIN A TIDY WORK SITE DURING CONSTRUCTION, MAINTENANCE OR DEMOLITION TO REDUCE RISK OF TRIPS AND FALLS IN THE WORKPLACE, MATERIALS FOR CONSTRUCTION OR MAINTENANCE SHOULD BE STORED IN DESIGNATED AREAS AWAY FROM ACCESS WAYS AND WORK AREAS
- 6. CONSTRUCTION OF BUILDING ELEMENTS THAT ARE NECESSARY TO CONTRIBUTE TO SAFE ACCESS TO THE BUILDING, SUCH AS HANDRAILS, SCAFFOLDING, ACCESS STAIRS, FALL ARREST SYSTEMS ETC., MUST TAKE PLACE PRIOR TO PROGRESSING WITH ANY OTHER WORKS FOR WHICH THOSE ELEMENTS WILL BE REQUIRED.

IF THE BUILDING SITE IS ADJACENT TO ANY BODY OF WATER ADEQUATE PROTECTION AND ACCESS PREVENTION SHALL BE PROVIDED. THE CONTRACTOR IS TO PREPARE A SAFE WORK METHOD STATEMENT FOR ANY WORKS REQUIRED TO BE UNDERTAKEN OVER WATER.

LIGHTING AND VENTILATION:

THE CONTRACTOR IS TO PROVIDE ADEQUATE LIGHTING AND VENTILATION TO ALL AREAS REQUIRED TO BE OCCUPIED BY WORKERS DURING CONSTRUCTION. PRIOR TO THE COMMISSIONING OF THE BUILDING, FINAL LIGHTING AND VENTILATION MUST BE PROVIDED IN ACCORDANCE WITH THE REQUIREMENTS OF THE NCC.

FIRE AND EMERGENCY:

ADEQUATE SITE SPECIFIC FIRE EQUIPMENT AND EMERGENCY EVACUATION PROCEDURES ARE TO BE PROVIDED AND MAINTAINED BY THE CONTRACTOR DURING WORKS ONSITE ACCORDING TO A SAFE WORK METHOD STATEMENT TO BE PREPARED BY THE CONTRACTOR PRIOR TO WORKS COMMENCING ONSITE. PRIOR TO THE COMMISSIONING OF THE BUILDING, FINAL FIRE PROTECTION EQUIPMENT SHALL BE PROVIDED IN ACCORDANCE WITH THE REQUIREMENTS OF THE NCC.

- 1. THE CONTRACTOR IS TO CONDUCT WORKS IN ACCORDANCE WITH THE CODES OF PRACTICE: "WORKING IN THE VICINITY OF OVERHEAD AND UNDERGROUND ELECTRIC LINES" AND "MANAGING ELECTRICAL RISKS IN THE WORKPLACE" (CP117) AND AS3012 STANDARD CONTROLS.
- 2. UNDERGROUND POWER LINES MAY BE LOCATED IN OR AROUND THE SITE. ALL UNDERGROUND POWER LINES MUST BE ACCURATELY LOCATED AND EITHER DISCONNECTED OR ADEQUATE EXCLUSION ZONES DELINEATED PRIOR TO ANY CONSTRUCTION. MAINTENANCE OR DEMOLITION WORK COMMENCING.
- 3. OVERHEAD POWER LINES MAY BE LOCATED ON OR NEAR THE SITE. THESE POSE A SIGNIFICANT RISK IF STRUCK OR APPROACHED BY LIFTING DEVICES OR OTHER PLANT AND PERSONS WORKING ABOVE GROUND LEVEL. WHERE THERE IS A DANGER OF THIS OCCURRING. POWER LINES SHOULD BE, WHERE PRACTICAL, DISCONNECTED OR RELOCATED. WHERE THIS IS NOT PRACTICAL, CLEARLY IDENTIFIED EXCLUSION ZONES AND APPROACH DISTANCES SHALL BE ESTABLISHED AND MAINTAINED.

EXCAVATION

- 1. THE CONTRACTOR IS TO CONDUCT WORKS IN ACCORDANCE WITH THE CODE OF PRACTICE: "EXCAVATION WORK" (CP107) STANDARD CONTROL.
- 2. CONSTRUCTION OF THE BUILDING AND SOME MAINTENANCE ON THE BUILDING MAY REQUIRE EXCAVATION AND INSTALLATION OF ITEMS WITHIN THE EXCAVATION. WHERE PRACTICAL, INSTALLATION SHOULD BE CARRIED OUT USING METHODS THAT DO NOT REQUIRE WORKERS TO ENTER THE EXCAVATION. WHERE THIS IS NOT PRACTICAL, ADEQUATE SUPPORT FOR THE EXCAVATED AREA SHALL BE PROVIDED TO PREVENT COLLAPSE. WARNING SIGNS AND BARRIERS TO PREVENT ACCIDENTAL OR UNAUTHORISED ACCESS TO ALL EXCAVATIONS SHALL BE PROVIDED.
- 3. ANY AUGURING PROCEDURES MAY CAUSE A RISK OF FALLING INTO OPEN BORES. ALL BORES THEREFORE ARE TO BE CONCRETE FILLED AS SOON AS POSSIBLE. IN THE MEANTIME, ADEQUATE PROTECTION AND ACCESS PREVENTION SHALL BE PROVIDED.
- 4. THE CONTRACTOR IS TO CONSULT ANY SITE INVESTIGATION REPORTS ETC. BEFORE CONDUCTING ANY EXCAVATION WORKS. IN THE CASE OF ANY AREAS BEING IDENTIFIED AS HAVING GROUND CONTAMINATION PRESENT, A QUALIFIED SPECIALIST CONSULTANT SHALL BE ENGAGED TO PROVIDE REMEDIAL WORKS DESIGN AND RISK MITIGATION STRATEGIES.

CONSTRUCTION

- 1. THE CONTRACTOR IS TO CONDUCT WORKS IN ACCORDANCE WITH THE CODE OF PRACTICE: "FORMWORK AND FALSEWORK" STANDARD CONTROL.
- 2. ALL FORMWORK AND SUPPORTING SCAFFOLD STRUCTURES MUST BE DEIGNED TO CARRY THE CONSTRUCTION LOADING SPECIFIED WITH THIS SET OF DOCUMENTATION.
- 3. IN-SITU FORMWORK E.G. BONDEK / CONDECK MUST BE INSTALLED TO MANUFACTURES INSTRUCTIONS AND SUPPORTED DURING CONSTRUCTION AS RECOMMENDED. TEMPORARY SUPPORTS ARE NOT PROVIDED AS PART OF THIS DOCUMENTATION.
- 4. SLABS THAT SUPPORT CONTINUED TEMPORARY STRUCTURE MUST BE BACK PROPPED. BACK PROPPING MUST BE CHECKED AND APPROVED PRIOR TO ANY ADDITIONAL CONSTRUCTION LOADING
- 5. WALLS, COLUMN AND OTHER VERTICAL FORMWORK MUST BE CHECKED AND DESIGNED FOR POTENTIAL HYDROSTATIC LOADING DURING CONCRETE PLACEMENT.

PRECAST PANEL ERECTION:

- 1. THE CONTRACTOR IS TO CONDUCT WORKS IN ACCORDANCE WITH THE CODE OF PRACTICE: "PRECAST TILT-UP AND CONCRETE ELEMENTS IN BUILDING CONSTRUCTION" AND AS3580 STANDARD CONTROLS.
- 2. CONTRACTOR IS TO ENSURE THAT CRANE SIZE AND LOCATION IS ADEQUATELY ASSESSED FOR CAPACITY BEFORE PANELS ARE ERECTED. THIS IT TO INCLUDE BUT IS NOT LIMITED TO CRANE SUPPORT BEARING, LOCATION OF UNDERGROUND SERVICES, OVERTURNING, LIFTING CAPACITY, OVERHEARD OBSTRUCTIONS AND TRAFFIC HAZARDS.
- 3. CHAIN AND SLING SETUP FOR PANELS IS TO BE CHECKED AGAINST APPROVED PANEL LIFTING POINTS. WHERE APPROPRIATE AN APPROVED SPREADER BEAM IS TO BE USED.
- 4. PATHWAYS OF OVERHEAD TRAVEL OF PANELS ARE TO BE CLEARLY MARKED AND ACCESS TO THESE RESTRICTED DURING LIFTING.
- PANEL BEARING AND LOCATING PLATES AND DOWELS ARE TO BE CHECKED FOR FINAL LOCATION.
- 6. PANEL PROPPING AND TEMPORARY SUPPORT MUST BE LOCATED WITH APPROVED ANCHORS AND APPROPRIATE CHECKS AND DESIGNS FOR CAPACITY. NUMBER AND CONFIGURATION OF PROPS IS TO BE CONDUCTED PRIOR TO ERECTION. TEMPORARY SUPPORTING STRUCTURE DURING CONSTRUCTION IS NOT PROVIDED AS PART OF THESE DESIGN DOCUMENTS AND MUST BE OBTAINED PRIOR TO ERECTION.

FOR CONSTRUCTION

STRUCTURAL STEEL ERECTION:

1. THE CONTRACTOR IS TO CONDUCT WORKS IN ACCORDANCE WITH THE CODES OF PRACTICE: "WELDING PROCESSES" (CP134), "ABRASIVE BLASTING" (CP101) AND "SPRAY PAINTING AND POWDER COATING" (CP131) STANDARD CONTROLS.

(1 OF 2)



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51 York Street, PO Box 1971, Launceston TAS 7250 NORTH

NEW SHED 12 TI-TREE DRIVE ANSONS BAY TAS P DAVIS & L KENNY

SCALE: (A3)

	REV	AMENDMENT	DATE	ISSUED BY:	WORKPLAC
	01	APPROVAL	27/05/2025	Idavis	MOINI LA
				DRAWN BY:	
				LD	DWG: SCH03
				VDDDU/ED BA	
3)				СВМ	PROJECT: EE642
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*N*ORKPLACE HEALTH & SAFETY

wg: SCH03



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- 2. CONTRACTOR IS TO ENSURE THAT CRANE SIZE AND LOCATION IS ADEQUATELY ASSESSED FOR CAPACITY BEFORE THE FRAME IS ERECTED. THIS IT TO INCLUDING BUT IS NOT LIMITED TO CRANE SUPPORT BEARING, LOCATION OF UNDERGROUND SERVICES, OVERTURNING, LIFTING CAPACITY, OVERHEARD OBSTRUCTIONS AND TRAFFIC HAZARDS.
- 3. CHAIN AND SLING SETUP FOR FRAMING MEMBERS IS TO BE CHECKED AGAINST APPROVED LIFTING POINTS. WHERE APPROPRIATE AN APPROVED SPREADER BEAM IS TO BE USED.
- PATHWAYS OF OVERHEAD TRAVEL OF FRAMING MEMBERS ARE TO BE CLEARLY MARKED AND ACCESS TO THESE RESTRICTED DURING LIFTING.5. TEMPORARY PROPPING WORK IS TO BE PROVIDED TO ENSURE STABILITY OF THE FRAMES DURING ERECTION. ALL STEEL FRAMES ARE TO BE TEMPORARY BRACED. UNTIL STRUCTURE IS FULLY ERECTED AND ALL CONNECTIONS BOLTED OR WELDED TOGETHER AS REQUIRED. TEMPORARY SUPPORTING STRUCTURE DURING CONSTRUCTION IS NOT PROVIDED AS PART OF THESE DESIGN DOCUMENTS AND MUST OBTAINED PRIOR TO ERECTION.
- 6. SITE BASED TREATMENTS OF STEEL FRAMING MEMBERS (EG. CUTTING, WELDING, GRIT BLASTING, SPRAY PAINTING, ETC.) IS TO BE MINIMISED WHEREVER POSSIBLE. IF SITE BASED TREATMENT IS UNAVOIDABLE, ADEQUATE PROTECTION, SCREENING AND VENTILATION TO MINIMISE HAZARDS TO PERSONNEL IS TO BE PROVIDED.
- 7. AVOID SITE BASE HOT WORKS WHERE POSSIBLE. IF UNAVOIDABLE, SITE SPECIFIC PROCEDURES FOR HOT WORKS PERMITS ETC. ARE TO BE FOLLOWED.

- 1. THE CONTRACTOR IS TO CONDUCT WORKS IN ACCORDANCE WITH THE CODES OF PRACTICE: "MANAGING THE RISK OF FALLS AT WORKPLACES" (CP122), "PREVENTING FALLS IN HOUSING CONSTRUCTION" (CP127), "SCAFFOLDS AND SCAFFOLDING WORK" AND AS1657 STANDARD CONTROLS.
- SCAFFOLDING MUST BE SECURED AND BRACED TO RESIST OVERTURNING. SINGLE PROPS MUST NOT BE USED UNLESS A DESIGN CHECK ON STABILITY IS MADE AND THEY ARE FIXED TO A STABLE BASE AT MIDPOINTS
- 3. CONTRACTOR IS TO USE PASSIVE FALL PREVENTION DEVICE IF POSSIBLE (IE. FIXED PLATFORM, CHERRY PICKERS ETC.)

CONCRETE STRESSING:

- 1. CONTRACTOR IS TO ENSURE THAT CONCRETE STRENGTH MEETS REQUIRED CAPACITY AT TIME OF STRESSING.
- 2. RESTRICTED STRESSING AREAS ARE TO BE PROVIDED TO ALL AREAS WHERE STRESSING IS TAKING PLACED BOTH AT LIVE AND DEAD ENDS OF STRESSING DUCTS.
- CONTRACTOR MUST ENSURE THAT AT ALL TIMES DURING STRESSING ONLY QUALIFIED AND APPROVED PERSONNEL HAVE ACCESS TO DESIGNATED STRESSING AREAS.
- 4. SLABS THAT SUPPORT CONTINUED TEMPORARY STRUCTURE MUST BE BACK PROPPED. BACK PROPPING MUST BE CHECKED AND APPROVED PRIOR TO ANY ADDITIONAL CONSTRUCTION LOADING.

CRANES AND OTHER MECHANICAL PLANT:

- 1. THE CONTRACTOR IS TO CONDUCT WORKS IN ACCORDANCE WITH THE CODES OF PRACTICE: "CRANES", "MANAGING THE RISKS OF PLANT IN THE WORKPLACE" (CP123), "INDUSTRIAL LIFT TRUCKS" AND AS2550 STANDARD CONTROLS.
- MECHANICAL LIFTING OF MATERIALS AND COMPONENTS DURING CONSTRUCTION, MAINTENANCE OR DEMOLITION PRESENTS A RISK OF FALLING OBJECTS. CONTRACTORS SHOULD ENSURE THAT APPROPRIATE LIFTING DEVICES ARE USED. THAT LOADS ARE PROPERLY SECURED. AND THAT ACCESS TO AREAS BELOW THE LOAD IS PREVENTED OR RESTRICTED.
- 3. CONTRACTOR IS TO ENSURE THAT CRANE SIZE AND LOCATION IS ADEQUATELY ASSESSED FOR CAPACITY BEFORE ANY LIFT. THIS IT TO INCLUDE BUT IS NOT LIMITED TO CRANE SUPPORT BEARING, LOCATION OF UNDERGROUND SERVICES, OVERTURNING, LIFTING CAPACITY, OVERHEARD OBSTRUCTIONS AND TRAFFIC HAZARDS.

EXISTING BUILDINGS

DEMOLITION:

- 1. THE CONTRACTOR IS TO CONDUCT WORKS IN ACCORDANCE WITH THE CODE OF PRACTICE: "DEMOLITION WORK" (CP106) STANDARD CONTROL.
- 2. LOCATIONS OF EXISTING EMBEDDED LIVE SERVICES ARE TO BE ACCURATELY ESTABLISHED PRIOR TO ANY PENETRATION OF EXISTING STRUCTURE.
- 3. DO NOT CUT OR REMOVE ANY STRUCTURAL MEMBER PRIOR TO INSPECTION BY A SUITABLY QUALIFIED STRUCTURAL ENGINEER.
- 4. SEEK ADVICE FROM A SUITABLY QUALIFIED STRUCTURAL ENGINEER PRIOR TO CORING, CHASING, CUTTING OR REMOVAL OF EXISTING CONCRETE AND REINFORCEMENT.

EXISTING STRUCTURAL ADEQUACY:

- 1. WHERE EXISTING STRUCTURAL ELEMENTS ARE DAMAGED OR EXHIBIT SIGNIFICANT SECTION LOSS, A SUITABLY QUALIFIED STRUCTURAL ENGINEER SHALL BE ENGAGED TO DESIGN A SYSTEM FOR STABILISING / SUPPORTING THE EXISTING STRUCTURE, SUCH THAT ALL WORK AREAS WILL BE ADEQUATELY SAFE FOR BUILDING WORKS TO COMMENCE. ANY SIGNIFICANT SECTION LOSS OR CORROSION OF EXISTING STRUCTURAL ELEMENTS SHALL BE REPORTED TO THE ENGINEER PRIOR TO PROCEEDING WITH WORKS.
- 2. ANY EXISTING RETAINING STRUCTURES PRESENT ON THE SITE SHALL BE INSPECTED BY A SUITABLY QUALIFIED STRUCTURAL ENGINEER TO ASCERTAIN THE EXTENT OF ANY EXCLUSION ZONES REQUIRED. ESPECIALLY WITH REGARD TO ANY EXCAVATION, THE OPERATION OF HEAVY SURFACE PLANT AND EQUIPMENT. OR STOCKPILING MATERIAL ADJACENT TO EXISTING RETAINING STRUCTURES

NORTH

3. NO EXCAVATION SHALL BE PERFORMED ADJACENT TO ANY EXISTING STRUCTURE, ESPECIALLY BELOW THE 45° LINE FROM THE UNDERSIDE OF AN EXISTING FOOTING WITHOUT THE EXPRESS PERMISSION OF THE STRUCTURAL ENGINEER.

- 1. THE CONTRACTOR IS TO CONDUCT WORKS IN ACCORDANCE WITH THE CODES OF PRACTICE: "HOW TO MANAGE AND CONTROL ASBESTOS IN THE WORKPLACE" (CP111) AND "HOW TO SAFELY REMOVE ASBESTOS" (CP115) STANDARD CONTROLS.
- 2. FOR ALTERATIONS TO OR DEMOLITION OF A BUILDING CONSTRUCTED PRIOR TO 1990, IF THE BUILDING WAS CONSTRUCTED PRIOR TO:
- 1990 IT MAY CONTAIN ASBESTOS;
- 1986 IT IS LIKELY TO CONTAIN ASBESTOS;

EITHER IN CLADDING MATERIAL OR IN FIRE-RETARDANT INSULATION MATERIAL. IN EITHER CASE, THE BUILDER SHOULD INSPECT AND, IF NECESSARY, HAVE ANY ASBESTOS REMOVED BY A SUITABLE QUALIFIED PERSON BEFORE DEMOLISHING, CUTTING, SANDING, DRILLING OR OTHERWISE DISTURBING THE EXISTING STRUCTURE.

EXISTING COATINGS:

PRIOR TO ANY WORKS COMMENCING AN APPROPRIATE METHOD OF PAINT REMOVAL AND DISPOSAL IS TO BE DETERMINED. PARTICULARLY ON HISTORIC STRUCTURES. COATINGS CONTAINING COAL TAR EPOXIES. BITUMEN AND ASPHALTS, ZINC CHROMATE AND LEAD AMONG OTHERS PRESENT A HEALTH RISK, ADEQUATE SCREENING IS TO BE PROVIDED TO THE PUBLIC AND THE SURROUNDING ENVIRONMENT DURING PAINT REMOVAL AND CLEANING OPERATIONS. ENVIRONMENTALLY APPROPRIATE METHODS ARE TO BE EMPLOYED DURING MAINTENANCE AND REPAIR WORK.

HAZARDOUS SUBSTANCES

THE CONTRACTOR IS TO CONDUCT WORKS IN ACCORDANCE WITH THE CODE OF PRACTICE: "MANAGING RISKS OF HAZARDOUS CHEMICALS IN THE WORKPLACE" (CP120) STANDARD CONTROL.

POWDERED MATERIALS:

MANY MATERIALS USED IN CONSTRUCTION CAN CAUSE HARM IF INHALED IN POWDERED FORM. PERSONS WORKING ON OR IN THE BUILDING DURING CONSTRUCTION, OPERATIONAL MAINTENANCE OR DEMOLITION SHOULD ENSURE GOOD VENTILATION AND WEAR PERSONAL PROTECTIVE EQUIPMENT, INCLUDING PROTECTION AGAINST INHALATION WHILE USING POWDERED MATERIAL OR WHEN SANDING, DRILLING, CUTTING OR OTHERWISE DISTURBING OR CREATING POWDERED MATERIAL.

TREATED TIMBER:

THE DESIGN OF THE BUILDING MAY INCLUDE PROVISION FOR INCLUSION OF TREATED TIMBER WITHIN THE STRUCTURE. DUST OR FUMES FROM THIS MATERIAL CAN BE HARMFUL. PERSONS WORKING ON OR IN THE BUILDING DURING CONSTRUCTION, OPERATIONAL MAINTENANCE OR DEMOLITION SHOULD ENSURE GOOD VENTILATION AND WEAR PERSONAL PROTECTIVE EQUIPMENT INCLUDING PROTECTION AGAINST INHALATION OF HARMFUL MATERIAL WHEN SANDING, DRILLING, CUTTING OR USING TREATED TIMBER IN ANY WAY THAT MAY CAUSE HARMFUL MATERIAL TO BE RELEASED. DO NOT BURN TREATED TIMBER.

VOLATILE ORGANIC COMPOUNDS:

MANY TYPES OF GLUES, SOLVENTS, SPRAY PACKS, PAINTS, VARNISHES AND SOME CLEANING MATERIALS AND DISINFECTANTS HAVE DANGEROUS EMISSIONS. AREAS WHERE THESE ARE USED SHOULD BE KEPT WELL VENTILATED WHILE THE MATERIAL IS BEING USED AND FOR A PERIOD AFTER INSTALLATION. PERSONAL PROTECTIVE EQUIPMENT MAY ALSO BE REQUIRED. THE MANUFACTURERS' RECOMMENDATIONS FOR USE MUST BE CAREFULLY FOLLOWED AT ALL TIMES.

SYNTHETIC MINERAL FIBRE:

GLASS FIBRE, ROCK WOOL, CERAMIC AND OTHER MATERIAL USED FOR THERMAL OR ACOUSTIC INSULATION MAY CONTAIN SYNTHETIC MINERAL FIBRE WHICH MAY BE HARMFUL IF INHALED, OR IF IT COMES INTO CONTACT WITH THE SKIN, EYES OR OTHER SENSITIVE PARTS OF THE BODY. PERSONAL PROTECTIVE EQUIPMENT, INCLUDING PROTECTION AGAINST INHALATION OF HARMFUL MATERIAL, SHOULD BE USED WHEN INSTALLING, REMOVING OR WORKING NEAR BULK INSULATION MATERIAL.

HAZARDOUS MANUAL TASKS

- 1. THE CONTRACTOR IS TO CONDUCT WORKS IN ACCORDANCE WITH THE CODE OF PRACTICE: "HAZARDOUS MANUAL TASKS" (CP110) STANDARD CONTROL.
- 2. COMPONENTS WITHIN THIS DESIGN WITH A MASS IN EXCESS OF 25 KG SHOULD BE LIFTED BY TWO OR MORE WORKERS OR BY A MECHANICAL LIFTING DEVICE. ALL MATERIAL PACKAGING, BUILDING AND MAINTENANCE COMPONENTS SHOULD CLEARLY SHOW THE TOTAL MASS OF PACKAGES AND WHERE PRACTICAL ALL ITEMS SHOULD BE STORED ON SITE IN A WAY THAT MINIMISES BENDING BEFORE LIFTING. ADVICE SHOULD BE PROVIDED ON SAFE LIFTING METHODS IN ALL AREAS WHERE LIFTING MAY OCCUR.

CONFINED SPACES

- 1. THE CONTRACTOR IS TO CONDUCT WORKS IN ACCORDANCE WITH THE CODE OF PRACTICE: "CONFINED SPACES" (CP103) AND AS 2865 STANDARD CONTROLS.
- 2. ENCLOSED SPACES WITHIN THE BUILDING MAY PRESENT A RISK TO PERSONS ENTERING FOR CONSTRUCTION. MAINTENANCE OR ANY OTHER PURPOSE, WHERE WORKERS ARE REQUIRED TO ENTER ENCLOSED SPACES, AIR TESTING EQUIPMENT AND PERSONAL PROTECTIVE EQUIPMENT SHALL BE PROVIDED. ONLY TRAINED PERSONNEL ARE TO ENTER A CONFINED SPACE AND THE CONTRACTOR IS TO PREPARE A WORK METHOD STATEMENT ADDRESSING MITIGATION OF RISKS FOR ANY SUCH WORKS. ADEQUATE SIGNAGE IS TO BE PROVIDED TO ALL TEMPORARY AND PERMANENT CONFINED SPACES IN ACCORDANCE WITH AS 2865.

NOISE

SCALE: (A3)

THE CONTRACTOR IS TO CONDUCT WORKS IN ACCORDANCE WITH THE CODE OF PRACTICE: "MANAGING NOISE AND PREVENTING HEARING LOSS AT WORK" (CP118) STANDARD CONTROL.

THE BUILDING HAS BEEN DESIGNED FOR THE SPECIFIC USE AS IDENTIFIED ON THE DRAWINGS. WHERE A CHANGE OF USE OCCURS AT A LATER DATE, A FURTHER ASSESSMENT OF THE WORKPLACE HEALTH AND SAFETY ISSUES SHOULD BE UNDERTAKEN.

FOR CONSTRUCTION

(2 OF 2)





51 York Street, PO Box 1971, Launceston TAS 7250

NEW SHED 12 TI-TREE DRIVE ANSONS BAY TAS P DAVIS & L KENNY

AMENDMENT	DATE		V
APPROVAL	27/05/2025	Idavis	•
		DRAWN BY:	
		LD	D
		APPROVED BY:	١٦
		СВМ	P
			APPROVAL 27/05/2025 Idavis DRAWN BY: LD APPROVED BY:

WORKPLACE HEALTH & SAFETY

wg: SCH04 PROJECT: **EE642**

www.cbmsustainabledesign.com.au

12 TI-TREE DRIVE ANSONS BAY TAS

CBM Sustainable Design

LTN: 51 York Street, PO Box 1971, Launceston TAS 7250 HBT: #Hobart Address VIC: #VIC Address NSW: #NSW Address

PROJECT: **EE642** P: +613 6332 6988 E: info@cbmgroup.com.au A: CC1113Z

22/08/2025

TRANSMITTAL

P DAVIS & L KENNY

DWG NO.	DRAWING	REV	ISSUED
	TYPICAL ROOF DETAILS		
	LIGHTING CALCULATIONS		
	GROUND FLOOR FRAMING PLAN		
	ROOF FRAMING PLAN		
A000	COVER PAGE	03	⊠
A101	LOCATION PLAN	02	
A102	PROPOSED SITE PLAN	03	
A103	SITE PLAN SHED	01	⋈
A104	BUSHFIRE MANAGEMENT PLAN		
A201	GROUND FLOOR PLAN	02	
A202	GROUND FLOOR RCP	01	
A203	ROOF PLAN	02	
A204	PLAN / ROOF PLAN / ELEVATIONS	01	⊠
A301	ELEVATIONS	02	
A302	SECTION	01	
A401	INTERIOR PLANS AND ELEVATIONS		
A402	INTERIOR PLANS AND ELEVATIONS		
A501	TYPICAL WALL DETAILS	01	
A502	TYPICAL ROOF DETAILS	01	
A503	SHOWER WATERPROOFING	01	
A601	DOOR / WINDOW SCHEDULE	01	
A602	GLAZING / LIGHTING CALCULATIONS	01	
A603	ENERGY EFFICIENCY NOTES	01	
A604	SUPPLEMENTARY NOTES	01	
A605	BUSHFIRE CONSTRUCTION NOTES	01	
A606	BUSHFIRE CONSTRUCTION NOTES	01	
A607	DOOR / WINDOW SCHEDULE	01	⊠
A701	PERSPECTIVE VIEWS		
A801	GROUND FLOOR PLUMBING PLAN	01	
A802	PROPERTY SERVICE CONNECTION NOTES		
A803	GROUND FLOOR ELECTRICAL PLAN		
S100	COVER PAGE	01	
S101	SLAB & FOOTING PLAN / ROOF FRAMING PLAN	01	
S102	GROUND FLOOR WALL BRACING	01	
S103	TIE-DOWNS & WALL BRACING	01	
S104	STRUCTURAL DETAILS	01	
S105	STRUCTURAL DETAILS	01	
S106	STANDARD STRUCTURAL DETAILS	01	
S107	STRUCTURAL NOTES	01	
S108	STRUCTURAL NOTES	01 - WIP	
SCH01	WORKPLACE HEALTH & SAFETY	02	
SCH02	WORKPLACE HEALTH & SAFETY	02	
SCH03	WORKPLACE HEALTH & SAFETY	01	⊠
SCH04	WORKPLACE HEALTH & SAFETY	01	
SCH05	MATERIALS & FINISHES SCHEDULE		
SCH06	MATERIALS & FINISHES SCHEDULE		
SCH07	MATERIALS & FINISHES SCHEDULE		
SCH08	MATERIALS & FINISHES SCHEDULE		
SCH09	MATERIALS & FINISHES SCHEDULE		
SCH10	MATERIALS & FINISHES SCHEDULE MATERIALS & FINISHES SCHEDULE		
SCH10 SCH11	#### RDS		
SCH12	#### RDS		
SCH13	#### RDS		

RECIPIENT					 				DAT	E/	ISSL	JE F	ORN	IAT			 		
	27/04/2023	16/06/2023	27/05/2025	22/08/2025															
CLIENT:	E	E	E	E															l
P DAVIS & L KENNY	<u> </u>	Ļ	_	_															
BUILDING CONTRACTOR:	-	-	-	-															
PRIVATE BUILDING CERTIFIER:	-	-	-	-															
STATUTORY AUTHORITY:	E	Е	Е	Е															
WATER AUTHORITY:	-	-	-	-															
ACOUSTIC:	-	-	-	-															
CIVIL:	-	-	-	-															
ELECTRICAL:	-	-	-	-															
ENVIRONMENTAL:	-	-	-	-															
FIRE:	-	-	-	-															
GEOTECHNICAL:	-	-	-	-															
HERITAGE:	-	-	-	-															
HYDRAULIC:	-	-	-	-															
LAND SURVEYING:	-	-	-	-															
LANDSCAPING:	-	-	-	-															
MECHANICAL:	-	-	-	-															
QUANTITY SURVEYING:	-	-	-	-															
STRUCTURAL:	-	-	-	-															
-	-	-	-	-															
-	-	-	-	-															

ADDITIONAL ASSOCIATED DOCUMENTS	MARK	ISSUED
CERTIFICATE OF TITLE	-	-
SOIL TEST / SITE ASSESSMENT	-	-
ON-SITE WASTEWATER DESIGN	-	-
FORM 35 (BUILDING & PLUMBING DESIGN) CERTIFICATION	-	-
FORM 35 (STRUCTURAL DESIGN) CERTIFICATION	-	-
-	-	-
-	-	-
-	-	-

CBM Sustainability Pty Ltd

Project consulting solutions

ABN: 89 677 248 547

22082025

Break O'Day Council admin@bodc.tas.gov.au

RE: DA 2025/00097 REQUEST FOR INFORMATION

1.

A2

Dwellings, excluding outbuildings with a <u>building</u> <u>height</u> of not more than 2.4m and protrusions that extend not more than 0.9m horizontally from the <u>building</u>, must have a <u>setback</u> from side and rear boundaries of not less than 5m.

P2

The siting of a <u>dwelling</u> must not cause an unreasonable loss of <u>amenity</u> to <u>adjoining</u> properties, having regard to:

- (a) the topography of the site;
- (b) the size, shape and orientation of the site;
- (c) the setbacks of surrounding buildings;
- (d) the height, bulk and form of existing and proposed buildings;
- (e) the existing buildings and <u>private open</u> <u>space</u> areas on the <u>site</u>;
- (f) sunlight to <u>private open space</u> and windows of habitable rooms on <u>adjoining</u> properties; and
- (g) the character of <u>development</u> existing on established properties in the area.

Response P2

The proposed shed is set back 1m from the rear and side boundaries.

9 Boobyalla Drive adjoining property to the eastern side boundary has an existing shed set back approximately 4.5m.

COM

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9 Boobyalla Drive adjoining shed

10 Ti-Tree Drive adjoining property has multiple shrubs to adjoining boundary and has multiple buildings to the north and west see site plan.

The shed has a minimal impact on private open space of adjacent properties. The proposed shed is consistent with the residential house / shack character of area.

2.

C2.6.1 Construction of parking areas

Objective:	That parking areas are constructed to an appropriate <u>standard</u> .						
Acceptable Solutions	Performance Criteria						
A1	P1						
All parking, access ways, manoeuvring and circulation spaces must:	All parking, access ways, manoeuvring and circulation spaces must be readily						
(a) be constructed with a durable all weather pavement;	identifiable and constructed so that they are useable in all weather conditions, having regard to:						
(b) be drained to the <u>public stormwater system</u> , or contain stormwater on the <u>site;</u> and	(a) the nature of the <u>use;</u>						
(c) excluding all uses in the Rural Zone, Agriculture Zone, Landscape Conservation Zone, Environmental	(b) the topography of the <u>land</u> ;						
Management Zone, Recreation Zone and Open Space Zone, be surfaced by a spray seal, asphalt, concrete,	(c) the drainage system available;						



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pavers or equivalent material to restrict abrasion from traffic and minimise entry of water to the pavement.

- (d) the likelihood of transporting sediment or debris from the <u>site</u> onto a <u>road</u> or public place;
- (e) the likelihood of generating dust; and
- (f) the nature of the proposed surfacing.

Response

The new driveway noted on the site plan is to provide access to store a motorboat used on an occasional basis. It is intended for the access to be consistent with the area and to be a natural free draining surface. It is not intended to be a sealed driveway with use as per a city residence. The site plan has been amended to note access (and not driveway).

See photos below of typical access ways (driveway) to sheds and dwellings.







Access to 9 Boobyalla Drive

3.

Currently there is no stormwater management system for Ansons Bay, roof water is collected in a rainwater storage tank and the overflow is directed to the open culvert in the street. The existing rainwater storage tank has a 90mm overflow, the belowground SW line is 100mm to a pit, and has a drainage point for charged water from the house.



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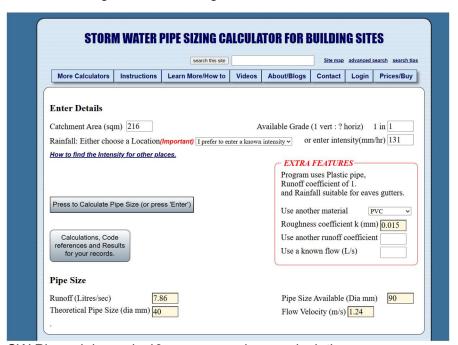
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It is intended for the shed stormwater to be dealt with in the same manner. The existing water harvesting tank is 2400mm litres.





View of existing rainwater storage tank and boat to be stored in shed



SW Pipe minimum is 40mm as per above calculations.

Is it necessary for the owners to pay a hydraulics engineers to do calculations? Kind Regards,



Lisa Davis



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