32-34 Georges Bay Esplanade St Helens Tasmania 7216 T: 03 6376 7900 ABN 96 017 131 248



Development Applications

Notice is hereby given under Section 57(3) of the Land Use Planning & Approvals Act 1993 that an application has been made to the Break O' Day Council for a permit for the use or development of land as follows:

DA Number DA 2025 / 00172 **Applicant Engineering Plus**

Proposal Storage - Construction of a Shed

Location 77 High Street, Mathinna (CT 208005/11)

Plans and documents can be inspected at the Council Office by appointment, 32 - 34 Georges Bay Esplanade, St Helens during normal office hours or online at www.bodc.tas.gov.au.

Representations must be submitted in writing to the General Manager, Break O'Day Council, 32 -34 Georges Bay Esplanade, St Helens 7216 or emailed to admin@bodc.tas.gov.au, and referenced with the Application Number in accordance with section 57(5) of the abovementioned Act during the fourteen (14) day advertised period commencing on Saturday 20th December 2025 until 5pm Tuesday 13th January 2026.

John Brown **GENERAL MANAGER**



DRAWING SCHEDULE

A00 COVER PAGE
A01 LOCALITY PLAN
A02 SITE PLAN
A03 RFI NOTES

PROJECT INFORMATION

BUILDING DESIGNER: GRANT JAMES PFEIFFER

ACCREDITATION No: CC2211T

ZONE: 12.0 VILLAGE ZONE

BUILDING CLASS:

LAND TITLE REFERENCE NUMBER:

DESIGN WIND SPEED:

SOIL CLASSIFICATION:

CLASS 10

208005/11

ASSUME "N2"

ASSUME "H1"

CLIMATE ZONE: 7
BUSHFIRE-PRONE BAL RATING: N/A
ALPINE AREA: N/A
CORROSION ENVIRONMENT: LOW
FLOODING: NO
LANDSLIP: NO

DISPERSIVE SOILS: UNKNOWN SALINE SOILS: UNKNOWN

SAND DUNES: NO MINE SUBSIDENCE: NO LANDFILL: NO

GROUND LEVELS: REFER PLAN

ORG LEVEL: 75mm ABOVE GROUND LEVEL

PROPOSED SHED

Z. YOUNG 77 HIGH STREET MATHINNA TAS 7214


BREAK O DAY COUNCIL

ISSUED FOR DEVELOPMENT APPROVAL

DEVELOPMENT A	DEVELOPMENT AREA		
Name	Area		
PROPOSED SHED	146.40 m²		
	1.1C 10 m²		





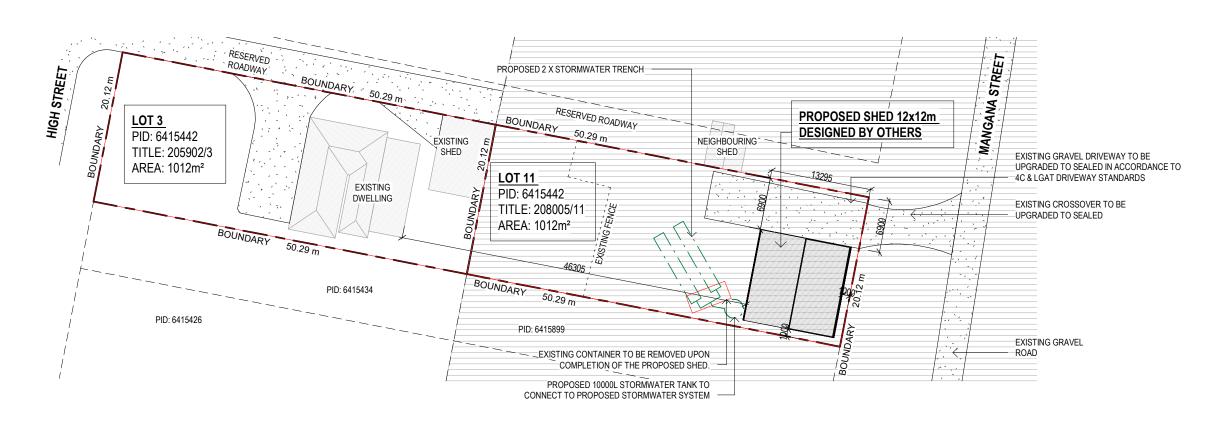

LOCALITY PLAN

LEGEND SEWER WATER STORMWATER **BUSHFIRE PRONE AREA**

ALL DRAINAGE WORK SHOWN IS PROVISIONAL ONLY AND IS SUBJECT TO AMENDMENT TO COMPLY WITH THE REQUIREMENTS OF THE LOCAL AUTHORITIES. ALL WORK IS TO COMPLY WITH THE REQUIREMENTS OF NATIONAL PLUMBING AND DRAINAGE CODE AS3500 AND MUST BE CARRIED OUT BY A LICENCED TRADESMAN ONLY.

STORMWATER FROM PROPOSED SHED TO BE DIRECTED INTO EXISTING STORMWATER SYSTEM TO LOCAL COUNCIL REQUIREMENTS & A MODIFIED 4C ACCESS ROAD IS AN ALL-WEATHER ROAD WHICH COMPLIES WITH THE AUSTRALIAN ROAD RESEARCH BOARD "UNSEALED ROADS MANUAL – GUIDELINES TO GOOD PRACTICE", 3RD EDITION, MARCH 2009 AS A CLASSIFICATION

4C ACCESS ROAD AND THE FOLLOWING MODIFIED REQUIREMENTS:

-ALL-WEATHER CONSTRUCTION; -LOAD CAPACITY OF AT LEAST 20 TONNES, INCLUDING FOR BRIDGES AND CULVERTS;

-MINIMUM CARRIAGEWAY WIDTH OF 4 METRES;

-MINIMUM VERTICAL CLEARANCE OF 4 METRES

-MINIMUM HORIZONTAL CLEARANCE OF 0.5 METRES FROM THE EDGE OF THE CARRIAGEWAY;

-CROSS FALLS OF LESS THAN 3° (1:20 OR 5%);

-DIPS LESS THAN 7° (1:8 OR 12.5%) ENTRY AND EXIT ANGLE;

-CURVES WITH A MINIMUM INNER RADIUS OF 10 METRES; -MAXIMUM GRADIENT OF 15° (1:3.5 OR 28%) FOR SEALED ROADS, AND 10° (1:5.5 OR 18%) FOR UNSEALED ROADS; AND -TERMINATE WITH A TURNING AREA FOR FIRE APPLIANCES PROVIDED BY ONE OF THE FOLLOWING:

-A TURNING CIRCLE WITH A MINIMUM INNER RADIUS OF 10 METRES;

-A PROPERTY ACCESS ENCIRCLING THE BUILDING; OR -A HAMMERHEAD "T" OR "Y" TURNING HEAD 4 METRES WIDE AND 8 METRES LONG

BOTH TITLE: 205902/3 AND 208005/11 ARE UNDER THE SAME OWNERSHIP. THE CLIENT INTENDS TO USE THE PROPOSED SHED ON TITLE 208005/11 FOR RECREATIONAL VEHICLE STORAGE.

-				Dunia			
					Date Drawn: 25.08.25 Drawn: J. Chin	Proje Addr	
	С	R.F.I UPDATES	28.11.25	J.C	Checked: J. Pfeiffer Approved: J. Pfeiffer		
	В	R.F.I UPDATES	17.11.25	J.C	Scale: As Shown @ A3	Office: info@e	
	Α	DEVELOPMENT APPROVAL	15.09.25	J.C	Accredited Building Desi		
	-	ISSUED FOR REVIEW	10.09.25	J.C	Designer Name: J.Pfeiffer		
	Rev:	Amendment:	Date:	Int:	Accreditation No: CC221	i1T	

ISSUED FOR APPROVAL

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Client: Z. YOUNG

Project: PROPOSED SHED

Address:77 HIGH STREET


MATHINNA TAS 7214

ENGINEERING PLUS BUILDING DESIGN
PROJECT MANAGEMENT
CIVIL/STRUCTURAL ENG

Drawing No:

2025-278 A01 / A03

Rev C

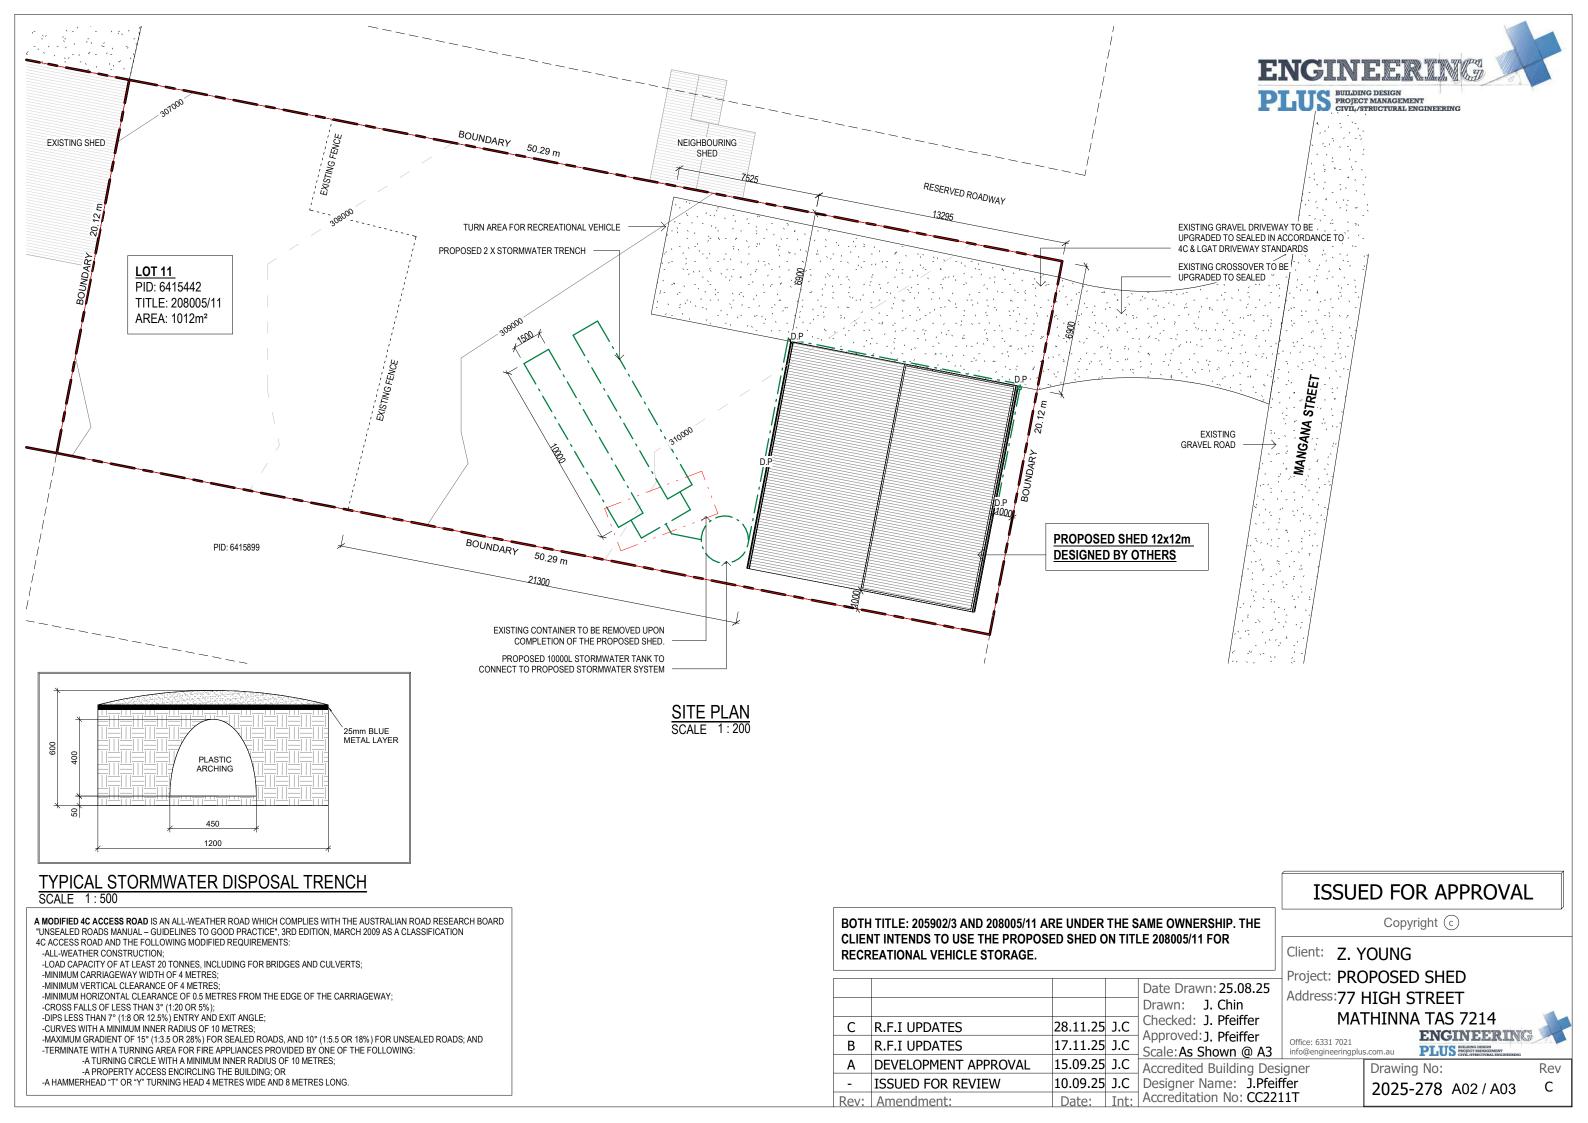

THE PROPOSED SHED WILL BE USED FOR RESIDENTIAL STORAGE OF RECREATIONAL VEHICLE FOR TITLE: 205902/3. BOTH TITLE: 205902/3 AND 208005/11 ARE UNDER THE SAME OWNERSHIP.

12.0 VILLAGE ZONE - PLANNING RESPONSES 12.3.1 ALL NON RESIDENTIAL USES

BOTH TITLE: 205902/3 AND 208005/11 ARE UNDER THE SAME OWNERSHIP. THE PROPOSED SHED WILL BE USED AS RESIDENTIAL STORAGE FOR THE NEIGHBOURING TITLE: 205902/3. THE PROPOSED SHED WILL BE USED FOR STORAGE OF RECREATIONAL VEHICLES.

12.4.3 SETBACK

THE PROPOSED SHED IS LOCATED ON A FLATTER PART OF THE PROPERTY, AT THE SOUTH-EAST CORNER. PLEASE REFER TO THE SITE PLAN FOR FURTHER TOPOGRAPHY INFORMATION.

BOTH NEIGHBOURING PROPERTIES ARE VACANT. THE CLOSEST ADJOINING BUILDING IS THE SHED AT 8 GIBLIN STREET, MATHINNA, WHICH IS LOCATED CLOSE TO THE WESTERN BOUNDARY: THEREFORE, THE PROPOSED SHED WILL BE CONSISTENT WITH THE STREETSCAPE OF MANGANA STREET

THE FORM OF THE PROPOSED SHED MATCHES THE EXISTING AND NEIGHBOURING BUILDINGS AND DOES NOT STAND OUT AMONG THE SURROUNDING STRUCTURES. THE HEIGHT OF THE PROPOSED SHED IS 4725 MM, WHICH IS SIMILAR TO THE HEIGHT OF OTHER NEIGHBOURING DWELLINGS AND SHEDS.

THE PROPOSED SHED IS LOCATED OFF THE MAIN STREET OF MATHINNA, HIGH STREET, AND IS HIDDEN FROM BENT STREET BY BUSHES. THEREFORE, THE PROPOSED SHED WILL NOT BE VISIBLE FROM MAIN ROADS IN MATHINNA.

DUE TO THE SIZE OF THE CROSSOVER AND DRIVEWAY, THE SITE WILL PROVIDE SAFE ACCESS FOR RECREATIONAL VEHICLES WHILE ALSO ENSURING SAFETY FOR OTHER ROAD USERS.

THE PROPOSED SHED IS LOCATED ON A FLATTER PART OF THE PROPERTY, AT THE SOUTH-EAST CORNER. PLEASE REFER TO THE SITE PLAN FOR FURTHER TOPOGRAPHY INFORMATION.

THE PROPERTY, TITLE 208005/11, HAS AN AREA OF 1012 M2 WITH A FRONTAGE OF 20.12 M ON MANGANA STREET. THE LONGER SIDES OF THE SITE (50.29 M) FACE NORTH AND SOUTH, ADJACENT TO A RESERVED ROADWAY AND PID: 6415899.

BOTH NEIGHBOURING PROPERTIES ARE VACANT. THE CLOSEST ADJOINING BUILDING IS THE SHED AT 8 GIBLIN STREET, MATHINNA, LOCATED CLOSE TO THE EASTERN BOUNDARY; THEREFORE, THE PROPOSED SHED WILL BE CONSISTENT WITH THE STREETSCAPE OF MANGANA STREET.

CURRENTLY, THE SITE (208005/11) AND ITS NORTHERN AND SOUTHERN NEIGHBOURS ARE VACANT. THEREFORE. THE PROPOSED SHED WILL NOT AFFECT ANY SURROUNDING PRIVATE OPEN SPACES OR AREAS.

THE FORM OF THE PROPOSED SHED MATCHES THE EXISTING AND NEIGHBOURING BUILDINGS AND DOES NOT STAND OUT AMONG THE SURROUNDING STRUCTURES. THE HEIGHT OF THE PROPOSED SHED IS 4725 MM, WHICH IS SIMILAR TO THE HEIGHT OF OTHER NEIGHBOURING DWELLINGS AND SHEDS.

THE NEIGHBOURING PROPERTIES OF 77 HIGH STREET, MATHINNA, CONTAIN MULTIPLE SHEDS, INCLUDING TITLES: 231121/2, 212058/9, AND 139870/1.THEREFORE, THIS DEVELOPMENT MATCHES THE AREA

C2.0 PARKING AND SUSTAINABLE TRANSPORT CODE C.2.5.1 CAR PARKING NUMBERS

THE PROPOSED SHED WILL BE USED FOR RESIDENTIAL STORAGE OF RECREATIONAL VEHICLE FOR TITLE: 205902/3. BOTH TITLE: 205902/3 AND 208005/11 ARE UNDER THE SAME OWNERSHIP. CLIENT WILL BE ABLE TO ACCESS THE SITE THROUGH FOOT FROM TITLE: 205902/3. THE RECREATIONAL VEHICLE WILL BE PARKED IN AND UNDER THE PROPOSED SHED.

THERE ARE NO PUBLIC TRANSPORTS NEARBY BUT IT IS ACCESSIBLE TO TITLE: 205902/3 WHERE THE CLIENT'S CARS WILL BE PARKED AT.

NO SITE CONSTRAINTS AS THE PROPOSED SHED IS LOCATED ON THE FLATTER PART OF THE PROPERTY.

DUE TO THE SIZE OF THE CROSSOVER AND DRIVEWAY, THE SITE WILL PROVIDE SAFE ACCESS FOR RECREATIONAL VEHICLES WHILE ALSO ENSURING SAFETY FOR OTHER ROAD USERS. ON STREET PARKING WILL BE SAFE AS WELL DUE TO THE DISTANCE BETWEEN EASTERN BOUNDARY TO MANGANA ROAD

P1.2 N/A

C2.0 PARKING AND SUSTAINABLE TRANSPORT CODE **C2.6.1 CONSTRUCTION OF PARKING AREAS**

THE EXISTING GRAVEL DRIVEWAY TO THE PROPOSED SHED WILL BE UPGRADED TO SEALED (PLEASE SEE PLANS). IT WILL BE DRAINED TO THE STORMWATER TRENCH ON SITE.

PLEASE SEE UPDATED PLANS A01 & A02.

C2.6.2 DESIGN AND LAYOUT OF PARKING AREAS

PLEASE SEE UPDATED PLANS A01 & A02. THE EXISTING GRAVEL DRIVEWAY WILL BE UPGRADED TO A SEALED DRIVEWAY TO MEET LGAT DRIVEWAY STANDARDS AND WILL BE USABLE IN ALL WEATHER CONDITIONS. THE WIDTH OF THE DRIVEWAY WILL PROVIDE A SAFE DISTANCE FOR BOTH PEDESTRIANS AND VEHICLES.

THE PROPOSED SHED WILL BE USED AS RESIDENTIAL STORAGE FOR THE NEIGHBOURING TITLE: 205902/3 AND WILL ACCOMMODATE RECREATIONAL VEHICLES. BOTH TITLE: 205902/3 AND 208005/11 ARE UNDER THE SAME OWNERSHIP.

AS THE PROPOSED SHED IS ACCESSIBLE FROM TITLE: 205902/3, WHERE THE CLIENT'S CARS WILL BE PARKED, NO ADDITIONAL CARPARKS ARE PROPOSED ON SITE. THE RECREATIONAL VEHICLES WILL BE STORED INSIDE THE SHED.

BRE-S2.0 STORMWATER MANAGEMENT SPECIFIC AREA PLAN

PLEASE SEE UPDATED PLANS A01 & A02. 2 X 10m x 1.5m TRENCHES HAVE BEEN PROPOSED TO ACCOMMODATE THE OVERFLOW OF THE 10 000L STORMWATER TANK.

ON SITE BUILDINGS:

A SHIPPING CONTAINER ON SITE WILL BE REMOVED UPON THE COMPLETION OF THE PROPOSED SHED. THE PROPOSED SHED WILL PROVIDE STORAGE FOR ELEMENTS CURRENTLY SCATTERED ON SITE.

Rev: Amendment:

ISSUED FOR APPROVAL

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Client: Z. YOUNG

Project: PROPOSED SHED

Address:77 HIGH STREET

MATHINNA TAS 7214 ENGINEERING

PLUS BUILDING DESIGN
PROJECT MANAGEMENT
CIVIL/STRUCTURAL ENG

Drawing No:

Rev

С

N/A

Date Drawn: 25.08.25 Drawn: J. Chin Checked: J. Pfeiffer C R.F.I UPDATES 28.11.25 J.C Approved: J. Pfeiffer R.F.I UPDATES 17.11.25 J.C Scale: As Shown @ A3 | info@engineeringplus.com.au DEVELOPMENT APPROVAL 15.09.25 J.C Accredited Building Designer ISSUED FOR REVIEW 10.09.25 J.C | Designer Name: J.Pfeiffer

Office: 6331 7021

Date: Int: Accreditation No: CC2211T


2025-278 A03 / A03

Building For: Zannette Young 77 High Street Mathinna Job Number: 100696 Produced by: Fair Dinkum Builds Launceston Phone: 03 6334 5535 4.72 m (max) Left LeanTo 3.7m 2.8m 2:2m 3.3m 3.3m 50 Left End Right End


Side

4.2m


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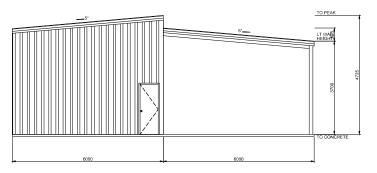


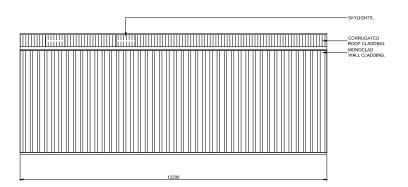



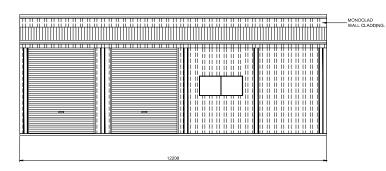



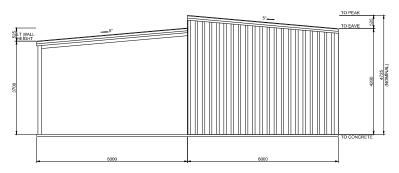



BUILDING COLOURS				
WALL	SHALE GREY			
ROOF	MONUMENT			
ROLLER DOOR	MONUMENT			
P.A. DOOR	MONUMENT			
WINDOW	MONUMENT			
DOWNPIPE	N/A - downpipes by other			
GUTTER	MONUMENT			
CORNER FLASHING	MONUMENT			
BARGE FLASHING	MONUMENT			
OPENING FLASHING	MONUMENT			

FAIR DINKUM BUILDS LAUNCESTON YOUNG (ZANNETTE) FOR FDB ΜT

77 HIGH STREET





Civil & Structural Engineers 50 Punari Stree Currajong, Qld 4812 Fax: 07 4725 5850 Email: design@nceng.com.au

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Registered Engineer - (Civil) TAS
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Mr Timothy Roy Messer BE MIEAust RPEQ

Engineers Register